

Mt. Juliet, Tennessee Board of Zoning Appeals Agenda

Thursday, January 9, 2025

6:00 PM

Commission Chambers

Members: Chairperson Ray Wallace, Jim Pustejovsky, Larry Searcy, David Heflin, David Rast

Resources: Jon Baughman, Deputy Planning Director, Jill Johnson, Planning, Matt White, Public Works Director

1. Call to Order

2. Approval of Minutes

2.A. Adopt the Minutes from the September 12, 2024 Board of Zoning Appeals Meeting.

3. New Business

- **3.A.** Review the Conditional Use Permit for the New Telecommunications Tower, located at 300 Pleasant Grove Rd.
- **3.B.** Review the Zoning Variance Application for the New Telecommunications Tower, located at 300 Pleasant Grove Rd.

4. Adjourn



Mt. Juliet, Tennessee Staff Report

2425 North Mt. Juliet Rd Mt. Juliet, TN 37122

File #: 0986 **Agenda Date:** 1/9/2025 **Agenda #:** 2.A.

Title:

Adopt the Minutes from the September 12, 2024 Board of Zoning Appeals Meeting.

Mt. Juliet, Tennessee Thursday, September 12, 2024 6:00 PM **Board of Zoning Appeals Meeting Minutes**



Members: Chairperson Ray Wallace, Jim Pustejovsky, Larry Searcy, David Heflin, David Rast

Resources: Jon Baughman, Deputy Planning Director, Jill Johnson, Planning, Matt White, Public Works Director

Rollcall

Board Member David Rast, Board Member Jim Pustejovsky, and Board **Present**

Member Larry Searcy

Board Member Dave Heflin, and Chairperson Ray Wallace Absent

1. Call to Order

2. **Approval of Minutes**

A motion was made by Board Member Heflin, seconded by Board Member Rast, that this be approved. The motion carried by the following vote:

APPROVED RESULT: MOVER: Jim Pustejovsky SECONDER: David Rast

Aye: Board Member Rast, Board Member Pustejovsky, and Board Member

Searcy

Board Member Heflin, and Chairperson Wallace Absent:

2A. Approve the Minutes for the March 14, 2024 Board of Zoning Appeals meeting.

3. **New Business**

3A. Review the Conditional Use request for an Accessory Structure Side Yard located at 91 John Wright Road.

A motion was made by Board Member Heflin, seconded by Board Member Rast, that this Action Item be approved. The motion carried by the following vote:

APPROVED RESULT: MOVER: Jim Pustejovsky

SECONDER: **David Rast** Aye: Board Member Rast, Board Member Pustejovsky, and Board Member

Searcy

Absent: Board Member Heflin, and Chairperson Wallace

4. Adjourn

A motion was made by Board Member Heflin, seconded by Board Member Rast, that this be approved. The motion carried by the following vote:

RESULT: APPROVED
MOVER: Jim Pustejovsky
SECONDER: David Rast

Aye: Board Member Rast, Board Member Pustejovsky, and Board Member

Searcy

Absent: Board Member Heflin, and Chairperson Wallace

Ray Wallace, Chairperson

Kenny Howell, Planning Commission Secretary



Mt. Juliet, Tennessee Staff Report

2425 North Mt. Juliet Rd Mt. Juliet, TN 37122

File #: 0988 **Agenda Date:** 1/9/2025 **Agenda #:** 3.A.

Title:

Review the Conditional Use Permit for the New Telecommunications Tower, located at 300 Pleasant Grove Rd.

MEMORANDUM



Date: January 9, 2025

To: Board of Zoning Appeals

From: Jon Baughman, City Planner

Jill Johnson, Planner I

Re: 150' Monopole Cell Tower Conditional Use Permit

Parking Variance Setback Variance Separation Variance

300 Pleasant Grove Road (Paddocks Walmart)

Map: 77
Parcel: 72.12

Request: SBA Towers X, Inc., seeks a conditional use permit and three variances before developing an intermediate impact facility (a new cell tower (antenna support structure)) at 300 Pleasant Grove Road (Walmart property) in the Paddocks PUD in District 3.

Analysis: The subject site is at 300 Pleasant Grove Road and is currently developed with a Walmart store on 23.62 acres. The property is zoned CMU-PUD. Staff has reviewed the PUD ordinances related to this development and the proposed tower does not violate any of the provisions within these documents, being a use permitted (intermediate impact facility) conditionally in CMU zoning districts. The applicant proposes a new 150' (159' w/ antennae included) tall cell antenna support tower of a stealth (pine tree) design and associated ground mounted equipment, access and utility easements and fencing. Zoning adjacent to this location is RS-40, low density residential, to the north.

Cell towers are classified as an intermediate impact use, a conditional use in CMU districts requiring a conditional use permit from the Board of Zoning Appeals before being permitted. There are approximately 9 FCC registered cell phone antennas within the city limits of Mt. Juliet. This does not include the small cell antennas that are currently being installed throughout the City.

<u>Plan Details:</u> The tower is proposed for the north side of the property on the north side of the Walmart building. The tower will be located on Walmart property but adjacent to 535 Pleasant Grove Road (m72p72.25) a residentially zoned parcel outside of the PUD boundaries. The scope of work includes the 150' tall stealth pine cell antenna support tower, ground mounted equipment boxes, fencing and a 12' wide gravel drive for access in a 20' wide utility access easement. The pad containing the pole and equipment, behind a chain link fence, is 50'x50' in area. Additionally, a 10' wide utility easement is proposed.

The height of the pole is 150' and the antenna structures are shown to exceed this height by 9'. This is permissible via the code, antennae being permitted to exceed tower height by up to 20'.

Separation distances from other towers are met, the nearest being over 3,000' away (min. required is 750' for a monopole tower such as what is proposed). Setbacks for commercially zoned land and separation from residentially zoned land regulations are not met and variances are requested, described below.

Article XIV, 14-106.4 General Provisions for Conditional Uses:

- 1. Burden of proof. A conditional use permit shall not be considered an entitlement and shall be granted by the Board of Zoning Appeals only after the applicant has demonstrated to the satisfaction of the Board that all required standards are met.
- 2. Ordinance compliance. The proposed use shall comply with all applicable regulations, including any specific standards for the proposed use set forth in this ordinance, unless circumstances qualify the proposed use for a variance. Any accessory use to a conditional use must receive express approval by the Board of [Zoning] Appeals.
- 3. General plan. A conditional use shall be in accordance with the general plan for the City. The Board of Zoning Appeals shall determine from its review that the location, design and operation of a conditional use is not an impediment to projected growth plans for the City and that adequate public facilities are available to accommodate the proposed use.
- 4. Traffic impact. The proposed use shall not adversely affect the safety and convenience of vehicular or pedestrian circulation and, in the opinion of the City Engineer, shall not decrease traffic flow below level of service D along any portion of public roadway where the property has frontage.
- 5. Parking adequacy. The facility shall provide off-street parking and loading facilities as required by the parking regulations of this ordinance.
- 6. Special conditions. In addition, the Board may restrict the hours of operation, establish permit expiration dates, require extraordinary setbacks and impose other reasonable conditions necessary to protect the public health, safety and welfare.

<u>Variances:</u> The applicant has requested two variances (three are required from staff's perspective) in conjunction with the above-described conditional use request:

- 1. 3-104.6.7.vii Setbacks (lot containing the tower) All towers shall be set back from all commercially and industrially zoned property lines a distance that is equal to or greater than one and one half times the height of the tower. All towers shall be set back from all residentially zoned property lines a distance that is two times the height of the tower or 200 feet, whichever is greater.
 - The applicant requests a 30' setback from the property line, rather than the 225' required by the code above.

STAFF DOES NOT SUPPORT

- 2. 3-104.6.7.vii.A Separation requirements (residentially zoned land) Towers shall be separated from all residentially zoned lands by a minimum of 200' or 200% of the height of the proposed tower, whichever is greater.
 - The applicant requests a separation from the adjacent residentially zoned land of 30' in lieu of the 300' required by the code above.

STAFF DOES NOT SUPPORT

3. 3-104.6.7.xii – Access – A parcel of land upon which a tower is located must provide access to at least one paved vehicular parking space on site.

The applicant requests to install a 12' wide gravel access drive within a 20' wide non-exclusive utility and maintenance easement, without a designated parking space in lieu. STAFF DOES NOT SUPPORT

14-105.4 *Standards for variances.* The Board shall not grant a variance, unless it makes findings based upon evidence presented to it as follows:

- 1. By reason of exceptional narrowness, shallowness, or shape of a particular piece of property at the time of enactment of this ordinance, or by reason of exceptional topographic conditions or other exceptional and extraordinary situation or condition of such piece of property, the strict application of any regulation contained within this ordinance would result in peculiar and exceptional practical difficulties to or exceptional or undue hardship upon the owner of such property.
- 2. The variance is the minimum variance that will relieve such difficulties or hardship and thereby make possible the reasonable use of the land, building, or structure.
- 3. The variance will not authorize activities in a zone district other than those permitted by this ordinance.
- 4. Financial returns only shall not be considered as a basis for granting a variance.
- 5. The granting of the variance will not be detrimental to the public welfare, injurious to other property or improvements in the area in which the subject property is located, or a substantial impairment to the intent and purpose of the zoning district wherein such property is located or of the general provisions of this ordinance.
- 6. The proposed variance will not impair an adequate supply of light and air to the adjacent property, or substantially increase the congestion in the public streets, or increase the danger of fire, or endanger the public safety.
- 7. The alleged difficulty or hardship has not been knowingly and intentionally created by any person having an interest in the property after the effective date of this ordinance.


<u>Summary:</u> This application is to request a conditional use permit for the construction of a 150' tall stealth cell tower support structure and associated improvements in the Paddocks PUD on the Walmart property. Also requested are three variances.

Staff supports approval of the conditional use permit for an intermediate impact facility at this location but does not support approval of the requested variances for reduced setbacks (30' in lieu of 225'), separation from residentially zoned land (30' in lieu of 300'), and parking, having not met all the standards for variances outlined above. However, the separation and setback variances are requested to avoid the tower being in the Walmart parking area and will facilitate the tower being placed in a less conspicuous area of the site.

<u>Recommendation:</u> Staff recommends approval of the conditional use permit and denial of the three variances described in this report, subject to the conditions of approval below:

- 1. Chain link fencing shall not permitted, provide a decorative alternative upon site plan submittal should the conditional use be approved.
- 2. Provide landscape screening and a landscape plan upon site plan submittal should the conditional use be approved.


- 3. Specify the colors of the entire structure upon site plan submittal, all requirements of 3-104.6.7.xi shall apply.
- 4. The drive aisle shall be paved with asphalt or concrete.
- 5. The parking space shall be paved with asphalt or concrete.
- 6. Should the conditional use be approved by the Board of Zoning Appeals, a site plan application shall be submitted to the Planning Department for review and approval before construction can begin. All requirements of article 3-104.6.7 shall be reviewed for compliance at this time.
- 7. Full compliance with setback requirements is required unless a variance is granted.
- 8. Full compliance with separation requirements is required unless a variance is granted.
- 9. Full compliance with parking requirements is required unless a variance is granted.

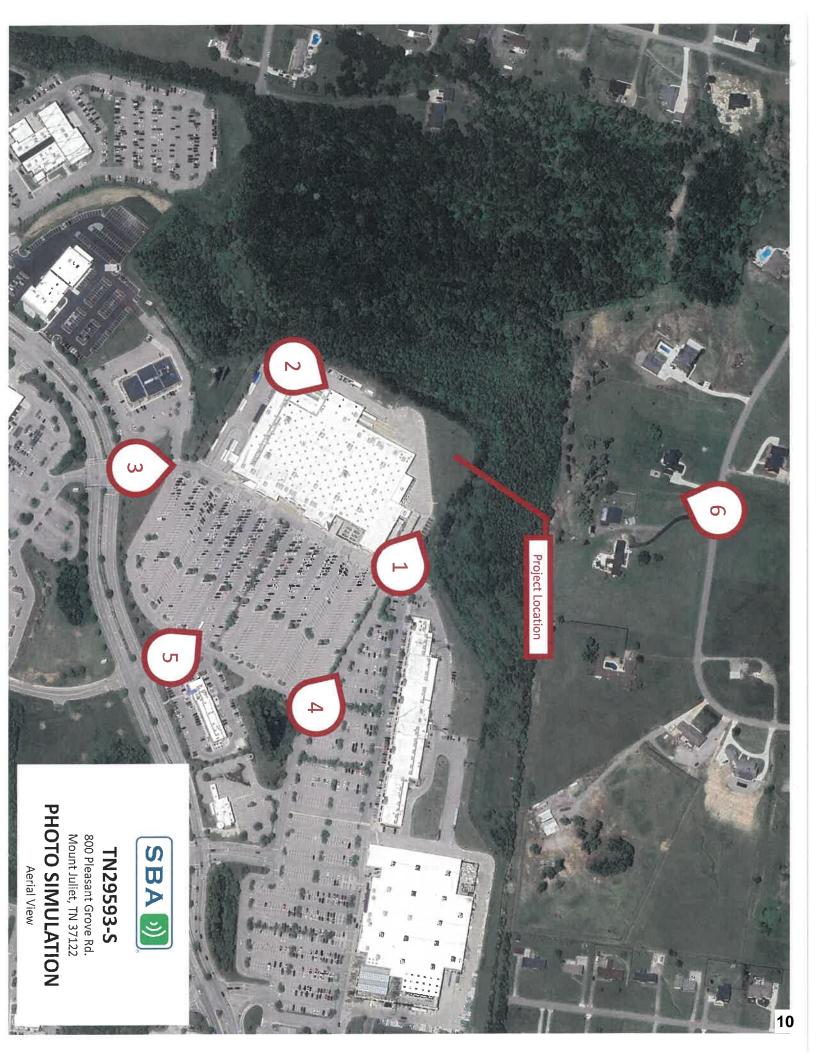








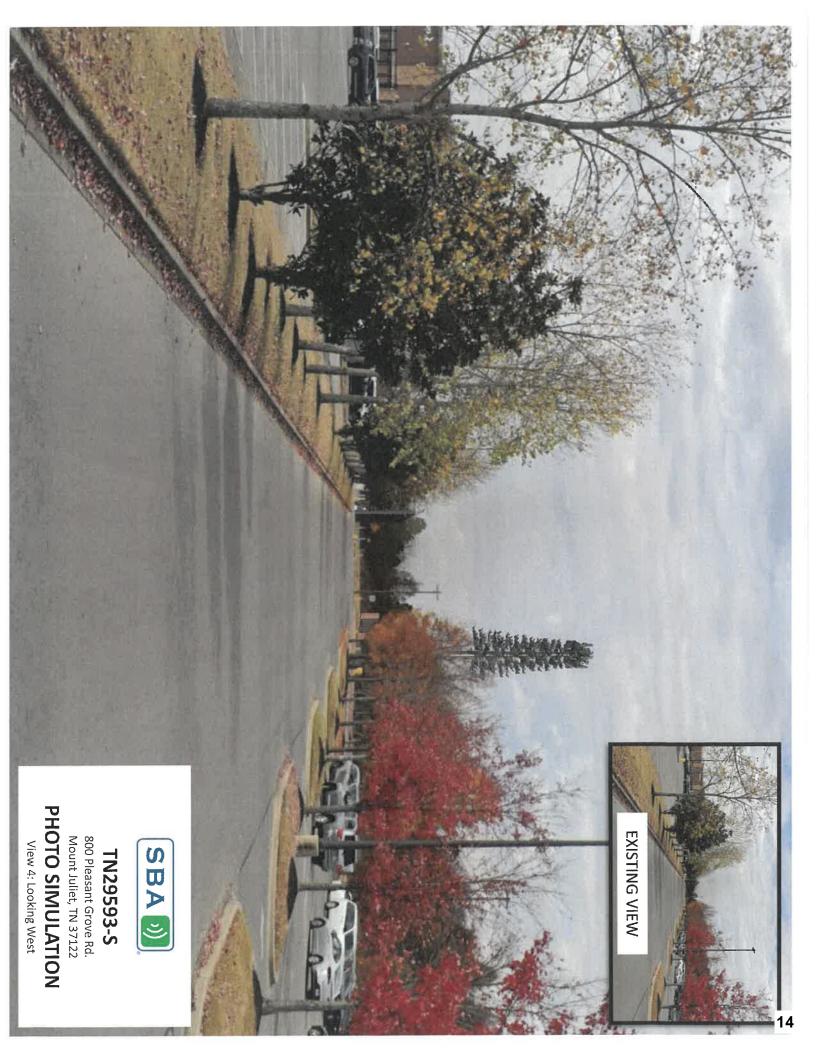

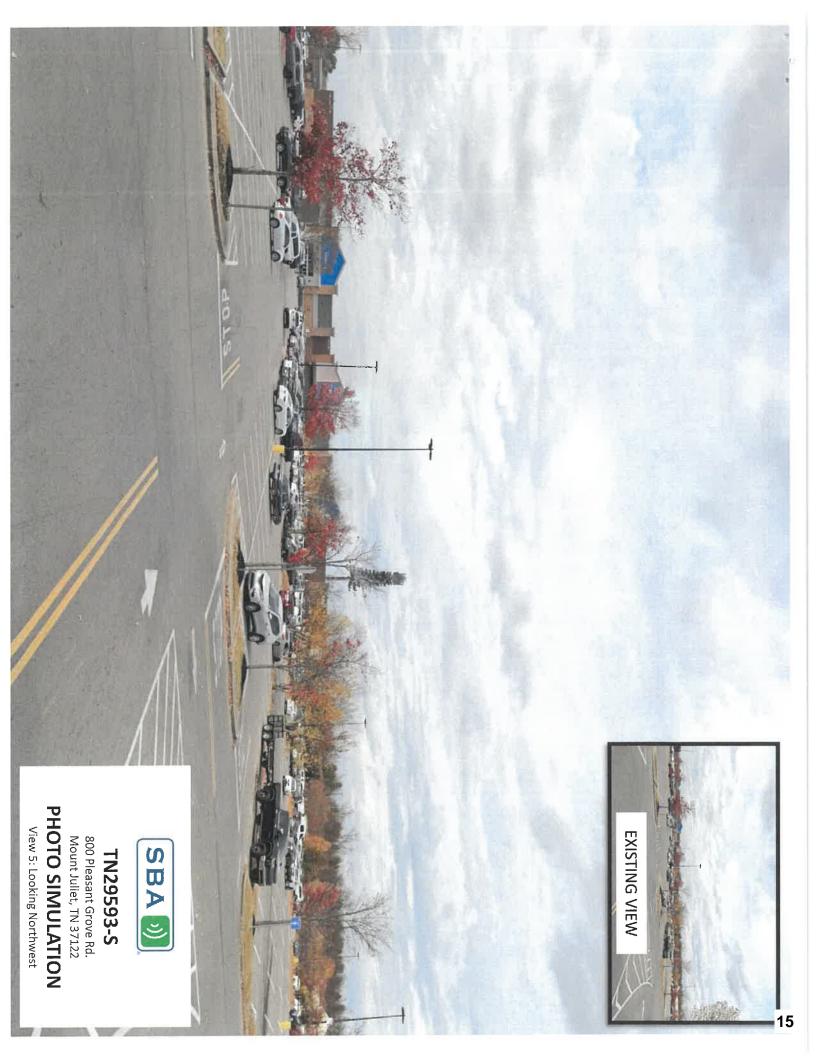



PROJECT SUMMARY

SITE NAME:

MT JULIET

SITE ADDRESS:

300 PLEASANT GROVE ROAD,

MOUNT JULIET, TN 37122

JURISDICTION:

CITY OF MOUNT JULIET WILSON COUNTY

COUNTY:

CMII-PLID

ZONING:

COMMERCIAL MIXED USE DISTRICT PLANNED UNIT DEVELOPMENT

PROPERTY OWNER:

WAL-MART REAL ESTATE

BUSINESS TRUST

ADDRESS:

APPLICANT:

ELEVATION:

P.O. BOX 8050 BENTONVILLE, AR 72716

SBA TOWERS IX LLC, 8051 CONGRESS AVENUE BOCA RATON, FL 33487 OFFICE: (800) 487-7483

JOSE MANCILLA / (561) 981-7381

FAX: (561) 226-3572

SBA CONTACT:

SITE COORDINATES:

LATITUDE: 36° 10′ 48.94″ N 86° 31′ 11.96″ W LONGITUDE:

645.32

(NAD 83/2011) (NAD 83/2011) (NAVD 88)

072.12-000 PARCEL NUMBER:

HANDICAPPED REQUIREMENTS

FACILITY IS UNMANNED AND NOT FOR HUMAN HABITATION. HANDICAP ACCESS NOT REQUIRED.

PLUMBING REQUIREMENTS

FACILITY HAS NO PLUMBING.

CONSULTING TEAM

ARCHITECTURAL - ENGINEERING FIRM: KIMLEY-HORN 655 NORTH FRANKLIN STREET SUITE 150 TAMPA, FL 33602

CONTACT: TONY DAWSON PHONE: (813) 620-1460

SURVEYING FIRM: GEOLINE SURVEYING, INC. 13430 NW 104TH TERRACE, SUITE A ALACHUA, FL 32615 CONTACT: ZACK WALL PHONE: (386) 418-0500

UTILITIES INFORMATION

POWER COMPANY:

FIBER COMPANY:

CONTACT: TBD PHONE: TBD

CONTACT: TBD PHONE: TBD



SITE NAME JULIET

SITE I.D. TN29593-S

E911 ADDRESS

300 PLEASANT GROVE ROAD, SUITE 600 MOUNT JULIET, TN 37122


PROJECT TYPE

MONOPINE CONSTRUCTION DRAWINGS

VICINITY MAP

- SITE LOCATION NOT TO SCALE

REGIONAL MAP

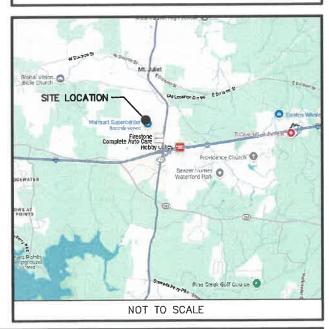

DRIVING DIRECTIONS

FROM NASHVILLE INTERNATIONAL AIRPORT:

DIRECTIONS: HEAD ONTO TERMINAL DRIVE AND MERGE ONTO I-40 E TOWARD KNOXVILLE. DRIVE FOR ABOUT 10 MILES ON I-40 E, THEN TAKE EXIT 226A FOR MT. JULIET ROAD NORTH (TN-171). MERGE ONTO MT. JULIET ROAD AND CONTINUE FOR ABOUT 1.5 MILES. NEXT, TURN RIGHT ONTO PLEASANT GROVE ROAD, AND THE SITE WILL BE ON THE LEFT AFTER APPROXIMATELY 0.3 MILES AT 300 PLEASANT GROVE ROAD.

SHEET SCALE FACTOR:

PLOT SIZE: 11"x17": "TO SCALE" 24"x36": 2X SCALE AS NOTED



CHEET INDEX

	SHEET INDEX
NO.	DESCRIPTION
T-1	TITLE SHEET
T-2	ABBREVIATIONS & SYMBOLS LEGEND
GN-1	GENERAL NOTES
GN-2	GENERAL NOTES
LS-1	LAND SURVEY
LS-2	LAND SURVEY
LS-3	LAND SURVEY
LS-4	LAND SURVEY / LEGAL DESCRIPTION
C-1	OVERALL SITE PLAN
C-2	ENLARGED SITE PLAN
C3	SITE GRADING PLAN
C-4	SITE ELEVATIONS
C-5	SITE DETAILS
C-6	FENCE DETAILS
E-1	UTILITY SITE PLAN
E-2	UTILITY DETAILS
E-3	SINGLE-LINE DIAGRAM
EG-1	GROUNDING PLAN & DETAILS
EG-2	GROUNDING DETAILS

Α	DATE	
TITLE	SIGNATURE	
SBA CONST. MGR:		
PROPERTY OWNER:		
PLANNING:		


THE ABOVE SHOWN PARTIES HEREBY APPROVE AND ACCEPT THESE DOCUMENTS AND AUTHORIZE THE CONTRACTOR TO PROCEED WITH THE CONSTRUCTION DESCRIBED HEREIN. ALL DOCUMENTS ARE SUBJECT TO REVIEW BY THE LOCAL BUILDING DEPARTMENT AND MAY IMPOSE CHANGES OR MODIFICATIONS.

ALL WORK SHALL BE PERFORMED AND MATERIALS INSTALLED IN ACCORDANCE WITH THE CURRENT EDITIONS OF THE FOLLOWING CODES AS ADOPTED BY THE OCAL GOVERNING AUTHORITIES. NOTHING IN THESE PLANS IS TO BE CONSTRUED TO PERMIT WORK NOT CONFORMING TO THESE CODES.

TBC 2012, LATEST EDITION TBC 2012, LATEST EDITION TPC 2012, LATEST EDITION BUILDING/DWELLING CODE: STRUCTURAL CODE: PLUMBING CODE: ECHANICAL CODE: TMC 2012, LATEST EDITION TEC 2017, LATEST EDITION FLECTRIC CODE: TLSC 2012, LATEST EDITION TRE CODE: TFC 2012, LATEST EDITION DESIGN WIND SPEED: RISK CATEGORY: EXPOSURE CATEGORY:

STATE COUNTY MAP

TENNESSEE

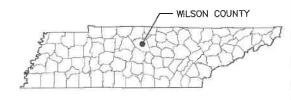

SBA NETWORK SERVICES, LLC. 8051 CONGRESS AVENUE BOCA RATON, FL 33487 TEL: (800) 487-7483

|Kimley»Horr

201 NORTH FRANKLIN STREET SUITE 1400 TAMPA, FL 33602 PHONE (813) 620-1460 WWW.KIMLEY-HORN.COM

THE INFORMATION CONTAINED IN THIS SET OF DOCUMENTS IS PROPRIETARY
BY NATURE. ANY USE OR DISCLOSURE OTHER THAN THAT WHICH RELATES TO THE CLIENT IS STRICTLY PROHIBITED.

A&E PROJECT #:	241149118
DRAWN BY:	JD\$
CHECKED BY:	SM
REV. 1 BY:	VJS

REVISIONS			3
_			
\triangle	11/26/24	ISSUED FOR	CONSTRUCTION
1	10/31/24	ISSUED FOR	REVIEW
NO.	DATE	DESCRIPTION	



SITE NAME:

MT JULIET

TN29593-S TE ADDRESS: 300 PLEASANT GROVE ROAD,

SUITE 600 MOUNT JULIET, TN 37122

RAWLAND

TITLE SHEET

SHEET NUMBER

ABBREVIATIONS

AB	ANCHOR BOLT	GR	GRADE
AC	ASPHALTIC CONCRETE	GYP	GYPSUM
A/C	AIR CONDITIONING	GFCI	GROUND FAULT CIRCUIT
ADJ	ADJUSTABLE		INTERRUPT
A.F.F.	ABOVE FINISH FLOOR	GND	GROUND
ARCH	ARCHITECTURAL	HC	HOLLOW CORE
APPROX	APPROXIMATELY	HDW	HARDWARE
A.G.L.	ABOVE GRADE LEVEL	HTR	HEATER
A.M.S.L.	ABOVE MEAN SEA LEVEL	НМ	HOLLOW METAL
BD	BOARD	HORIZ	HORIZONTAL
BLDG	BUILDING	HR	HOUR
BLKG	BLOCKING	НТ	HEIGHT
BOT	воттом	HV	HIGH VOLTAGE
	BASEMENT	ID	INSIDE DIMENSION
BSMT	BASE TRANSCEIVER	INS	INSULATION
BTS		INT	INTERIOR
	STATION	JT	JOINT
C	COURSE(S)	LAM	LAMINATED
CEM	CEMENT		POUNDS
CL	CHAIN LINK	LBS	
CLG	CEILING	LT	LIGHT
CLR	CLEAR	LA	LIGHTNING ARRESTOR
COL	COLUMN	LNA	LOW NOISE AMPLIFIER
CONC	CONCRETE	MFR	MANUFACTURER
CONST	CONSTRUCTION	MAT	MATERIAL
CONT	CONTINUOUS	MAX	MAXIMUM
CORR	CORRIDOR	MECH	MECHANICAL
CO	CONDUIT ONLY	MIN	MUMINIM
DIA	DIAMETER	MISC	MISCELLANEOUS
DBL	DOUBLE	ML	METAL LATH
DEPT	DEPARTMENT	MO	MASONRY OPENING
		MS	MACHINE SCREW
DEMO	DEMOLITION		
DEMO DIM	DEMOLITION DIMENSION	MTD	MOUNTED
DIM	DIMENSION	MTD	MOUNTED
DIM DN	DIMENSION DOWN	MTD MTL	MOUNTED METAL
DIM DN DR	DIMENSION DOWN DOOR	MTD MTL (N)	MOUNTED METAL NEW
DIM DN DR DTL	DIMENSION DOWN DOOR DETAIL	MTD MTL (N) NIC	MOUNTED METAL NEW NOT IN CONTRACT
DIM DN DR DTL DWG	DIMENSION DOWN DOOR DETAIL DRAWING	MTD MTL (N) NIC NO	MOUNTED METAL NEW NOT IN CONTRACT NUMBER
DIM DN DR DTL DWG (E)	DIMENSION DOWN DOOR DETAIL DRAWING EXISTING	MTD MTL (N) NIC NO NTS	MOUNTED METAL NEW NOT IN CONTRACT NUMBER NOT TO SCALE
DIM DN DR DTL DWG (E) EA	DIMENSION DOWN DOOR DETAIL DRAWING EXISTING EACH	MTD MTL (N) NIC NO NTS O	MOUNTED METAL NEW NOT IN CONTRACT NUMBER NOT TO SCALE OVERHEAD
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DIM DN DR DTL DWG (E) EA ELEC ELEV EQUIP EXP EXT FA FB FF FH FIN FLR FOS FS FT	DIMENSION DOWN DOOR DETAIL DRAWING EXISTING EACH ELECTRIC ELEVATION EQUIPMENT EXPANSION EXTERIOR FIRE ALARM FLAT BAR FINISH FLOOR FLAT HEAD FINISH(ED) FLOOR FACE OF STUDS FINISH SURFACE FOOT, FEET	MTD MTL (N) NIC NO NTS O OA O.C. OPNG OPP PARTN PL PLAS PLYWD POC PROP PT R REQD RD	MOUNTED METAL NEW NOT IN CONTRACT NUMBER NOT TO SCALE OVERHEAD OVERALL ON CENTER OPENING OPPOSITE PARTITION PLATE PLASTER PLYWOOD POINT OF CONNECTION PROPERTY PRESSURE TREATED RISER REQUIRED ROOF DRAIN
DIM DN DR DTL DWG (E) EA ELEC ELEV EQUIP EXP EXT FA FB FF FH FIN FLR FOS FS	DIMENSION DOWN DOOR DETAIL DRAWING EXISTING EACH ELECTRIC ELEVATION EQUIPMENT EXPANSION EXTERIOR FIRE ALARM FLAT BAR FINISH FLOOR FLAT HEAD FINISH(ED) FLOOR FACE OF STUDS FINISH SURFACE FOOT, FEET	MTD MTL (N) NIC NO NTS O OA O.C. OPNG OPP PARTN PL PLAS PLYWD POC PROP PT R REQD RD RM	MOUNTED METAL NEW NOT IN CONTRACT NUMBER NOT TO SCALE OVERHEAD OVERALL ON CENTER OPENING OPPOSITE PARTITION PLATE PLASTER PLYWOOD POINT OF CONNECTION PROPERTY PRESSURE TREATED RISER REQUIRED ROOF DRAIN ROOM
DIM DN DR DTL DWG (E) EA ELEC ELEV EQUIP EXP EXT FA FB FF FH FIN FLR FOS FS FT	DIMENSION DOWN DOOR DETAIL DRAWING EXISTING EACH ELECTRIC ELEVATION EQUIPMENT EXPANSION EXTERIOR FIRE ALARM FLAT BAR FINISH FLOOR FLAT HEAD FINISH(ED) FLOOR FACE OF STUDS FINISH SURFACE FOOT, FEET	MTD MTL (N) NIC NO NTS O OA O.C. OPNG OPP PARTN PL PLAS PLYWD POC PROP PT R REQD RD RM RMS	MOUNTED METAL NEW NOT IN CONTRACT NUMBER NOT TO SCALE OVERHEAD OVERALL ON CENTER OPENING OPPOSITE PARTITION PLATE PLASTER PLYWOOD POINT OF CONNECTION PROPERTY PRESSURE TREATED RISER REQUIRED ROOF DRAIN ROOM ROOMS
DIM DN DR DTL DWG (E) EA ELEC ELEV EQUIP EXP EXT FA FB FF FH FIN FLR FOS FS FT FTG	DIMENSION DOWN DOOR DETAIL DRAWING EXISTING EACH ELECTRIC ELEVATION EQUIPMENT EXPANSION EXTERIOR FIRE ALARM FLAT BAR FINISH FLOOR FLAT HEAD FINISH(ED) FLOOR FACE OF STUDS FINISH SURFACE FOOT, FEET	MTD MTL (N) NIC NO NTS O OA O.C. OPNG OPP PARTN PL PLAS PLYWD POC PROP PT R REQD RD RM RMS RO	MOUNTED METAL NEW NOT IN CONTRACT NUMBER NOT TO SCALE OVERHEAD OVERALL ON CENTER OPENING OPPOSITE PARTITION PLATE PLASTER PLYWOOD POINT OF CONNECTION PROPERTY PRESSURE TREATED RISER REQUIRED ROOF DRAIN ROOM ROOMS ROUGH OPENING
DIM DN DR DTL DWG (E) EA ELEC ELEV EQUIP EXP EXT FA FB FF FH FIN FLR FOS FS FT FTG FW	DIMENSION DOWN DOOR DETAIL DRAWING EXISTING EACH ELECTRIC ELEVATION EQUIPMENT EXPANSION EXTERIOR FIRE ALARM FLAT BAR FINISH FLOOR FLAT HEAD FINISH(ED) FLOOR FACE OF STUDS FINISH SURFACE FOOT, FEET FOOTING FINISH WALL	MTD MTL (N) NIC NO NTS O OA O.C. OPNG OPP PARTN PL PLAS PLYWD POC PROP PT R REQD RD RM RMS RO SC	MOUNTED METAL NEW NOT IN CONTRACT NUMBER NOT TO SCALE OVERHEAD OVERALL ON CENTER OPENING OPPOSITE PARTITION PLATE PLASTER PLYWOOD POINT OF CONNECTION PROPERTY PRESSURE TREATED RISER REQUIRED ROOF DRAIN ROOM ROOMS ROUGH OPENING SOLID CORE
DIM DN DR DTL DWG (E) EA ELEC ELEV EQUIP EXP EXT FA FB FF FH FIN FLR FOS FS FT FTG FW F.G.	DIMENSION DOWN DOOR DETAIL DRAWNG EXISTING EACH ELECTRIC ELEVATION EQUIPMENT EXPANSION EXTERIOR FIRE ALARM FLAT BAR FINISH FLOOR FLAT HEAD FINISH(ED) FLOOR FACE OF STUDS FINISH SURFACE FOOT, FEET FOOTING FINISH WALL FINISH GRADE	MTD MTL (N) NIC NO NTS O OA O.C. OPNG OPP PARTN PL PLAS PLYWD POC PROP PT R REQD RD RM RMS RO	MOUNTED METAL NEW NOT IN CONTRACT NUMBER NOT TO SCALE OVERHEAD OVERALL ON CENTER OPENING OPPOSITE PARTITION PLATE PLASTER PLYWOOD POINT OF CONNECTION PROPERTY PRESSURE TREATED RISER REQUIRED ROOF DRAIN ROOM ROOMS ROUGH OPENING SOLID CORE SCHEDULE
DIM DN DR DTL DWG (E) EA ELEC ELEV EQUIP EXP EXT FA FB FF FH FIN FLR FOS FS FT FTG FW F.G. FUT	DIMENSION DOWN DOOR DETAIL DRAWNG EXISTING EACH ELECTRIC ELEVATION EQUIPMENT EXPANSION EXTERIOR FIRE ALARM FLAT BAR FINISH FLOOR FLAT HEAD FINISH(ED) FLOOR FACE OF STUDS FINISH SURFACE FOOT, FEET FOOTING FINISH GRADE FUTURE	MTD MTL (N) NIC NO NTS O OA O.C. OPNG OPP PARTN PL PLAS PLYWD POC PROP PT R REQD RD RM RMS RO SC	MOUNTED METAL NEW NOT IN CONTRACT NUMBER NOT TO SCALE OVERHEAD OVERALL ON CENTER OPENING OPPOSITE PARTITION PLATE PLASTER PLYWOOD POINT OF CONNECTION PROPERTY PRESSURE TREATED RISER REQUIRED ROOF DRAIN ROOM ROOMS ROUGH OPENING SOLID CORE

SHT

SHEET


SIM	SIMILAR
SPECS	SPECIFICATIONS
SS	STAINLESS STEEL
STL	STEEL
STOR	STORAGE
STRUCT	STRUCTURAL
SUSP	SUSPENDED
SW	SWITCH
SWBO	SWITCHBOARD
THK	THICK
П	TENANT IMPROVEMENT
TMA	TOWER MOUNTED AMPLIFIER
TOS	TOP OF SURFACE
TS	TUBE STEEL
TYP	TYPICAL
U	UNDERGROUND
UNO	UNLESS NOTED
	OTHERWISE
VCT	VINYL
	COMPOSITION
	TILE
VERT	VERTICAL
V.I.F.	VERIFY IN FIELD
VG	VERTICAL GRAIN
W/	WITH
WD	WOOD
WR	WATER RESISTANT
WT	WEIGHT
XFMR	TRANSFORMER
@	AT
Г	CHANNEL
L	
ૡ	CENTERLINE




ANGLE

PROPERTY LINE


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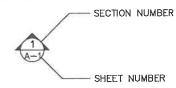
BUILDING SECTION REFERENCE

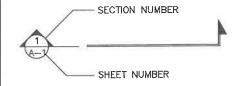


DETAIL REFERENCE

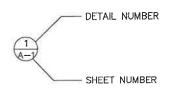

DETAIL SECTION REFERENCE

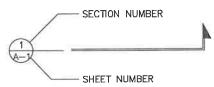

ELEVATION VIEW REFERENCE

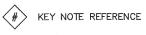


101) DOOR NUMBER

101 AREA AND/OR ROOM NUMBER



A MECHANICAL UNIT

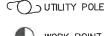

WORK POINT



#\ REVISION OR CONTROL POINT



ELEVATION REFERENCE

7///////	MASONRY
	BRICK
	CONCRETE
	EARTH
	STEEL
600000000000000000000000000000000000000	GRAVEL
	CENTER LINE
	PROPERTY LINE
	LEASE LINE
	EASEMENT LINE

RIGHT--OF-WAY CHAIN LINK FENCE WOOD FENCE

SILT FENCE BELOW GRADE ----UE----ELECTRIC

BELOW GRADE ____UT____ TELEPHONE

-----OE/OT-----ELECTRIC/TELEPHONE OVERHEAD TELEPHONE

OVERHEAD

OVERHEAD ELECTRIC CONTOUR

-276----TREE PROTECTION FENCE

TREE LINE



TREES, SHRUBS, BUSHES SANITARY SEWER LINE

- NG --

WATER LINE NATURAL GAS LINE



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A&E PROJECT #:	241149118
DRAWN BY:	JDS
CHECKED BY:	SM
REV. 1 BY:	VJS

	R	EVISIONS
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A	11/26/24	ISSUED FOR CONSTRUCTION
10	10/31/24	ISSUED FOR REVIEW
NO.	DATE	DESCRIPTION



SITE NAME:

MT JULIET

TN29593-S

ITE ADDRESS: 300 PLEASANT GROVE ROAD, SUITE 600 MOUNT JULIET, TN 37122

RAWLAND

ABBREVIATIONS & SYMBOLS LEGEND

Γ-2

GL

GLASS

2. ALL WORK PRESENTED ON THESE DRAWINGS MUST BE COMPLETED UNLESS NOTED OTHERWISE. THE CONTRACTOR MUST HAVE CONSIDERABLE EXPERIENCE IN PERFORMANCE OF WORK SIMILAR TO THAT DESCRIBED HEREIN. BY ACCEPTANCE OF THIS ASSIGNMENT, THE CONTRACTOR IS ATTESTING THAT HE DOES HAVE SUFFICIENT EXPERIENCE AND ABILITY. THAT HE IS KNOWLEDGEABLE OF THE WORK TO BE PERFORMED AND THAT HE IS LICENSED AND PROPERLY REGISTERED TO DO THIS WORK IN THE STATE AND/OR COUNTY IN WHICH IT IS TO BE PERFORMED.

S. UNILESS SHOWN OR NOTED OTHERWISE ON THE CONTRACT DRAWINGS, OR IN THE SPECIFICATIONS, THE FOLLOWING NOTES SHALL APPLY TO THE MATERIALS LISTED HEREIN, AND TO THE PROCEDURES TO BE USED ON THIS PROJECT.

4. ALL HARDWARE ASSEMBLY MANUFACTURER'S INSTRUCTIONS SHALL BE FOLLOWED EXACTLY AND SHALL SUPERCEDE ANY CONFLICTING NOTES ENCLOSED HEREIN.

IT IS THE CONTRACTOR'S SOLE RESPONSIBILITY TO DETERMINE ERECTION PROCEDURE AND SEQUENCE TO INSURE THE SAFETY OF THE STRUCTURE AND ITS COMPONENT PARTS DURING ERECTION AND/OR FIELD MODIFICATIONS. THIS INCLUDES, BUT IS NOT LIMITED TO, THE ADDITION OF WHATEVER TEMPORARY BRACING, GUYS OR TIE DOWNS THAT MAY BE NECESSARY. SUCH MATERIAL SHALL BE REMOVED AND SHALL REMAIN THE PROPERTY OF THE CONTRACTOR AFTER COMPLETION OF THE PROJECT

6. ALL DIMENSIONS, ELEVATIONS AND EXISTING CONDITIONS SHOWN ON THE DRAWINGS SHALL BE FIELD VERIFIED BY THE CONTRACTOR AND THE TESTING AGENCY PRIOR TO BEGINNING ANY MATERIALS ORDERING, FABRICATION OR CONSTRUCTION WORK ON THIS PROJECT. ANY DISCREPANCIES SHALL BE IMMEDIATELY BROUGHT TO THE ATTENTION OF THE OWNER AND THE OWNER'S ENGINEER. THE DISCREPANCIES MUST BE RESOLVED BEFORE THE CONTRACTOR IS TO PROCEED WITH THE WORK. THE CONTRACT DOCUMENTS DO NOT INDICATE THE METHOD OF CONSTRUCTION. THE CONTRACTOR SHALL SUPERVISE AND DIRECT THE WORK AND SHALL BE SOLELY RESPONSIBLE FOR ALL CONSTRUCTION MEANS, METHODS, TECHNIQUES, SEQUENCES AND PROCEDURES, OBSERVATION VISITS TO THE SITE BY THE OWNER AND/OR THE ENGINEER SHALL NOT INCLUDE INSPECTION OF THE PROTECTIVE MEASURES OR THE CONSTRUCTION PROCEDURES.

ALL MATERIALS AND EQUIPMENT FURNISHED SHALL BE NEW AND OF GOOD QUALITY, FREE FROM FAULTS AND DEFECTS AND IN CONFORMANCE WITH THE CONTRACT DOCUMENTS. ANY AND ALL SUBSTITUTIONS MUST BE PROPERLY APPROVED AND AUTHORIZED IN WRITING BY THE OWNER AND ENGINEER PRIOR TO INSTALLATION. THE CONTRACTOR SHALL FURNISH SATISFACTORY EVIDENCE AS TO THE KIND AND QUALITY OF THE MATERIALS AND EQUIPMENT BEING SUBSTITUTED.

MAINTAINING AND SUPERVISING ALL SAFETY PRECAUTIONS AND PROGRAMS IN CONNECTION WITH THE WORK. THE CONTRACTOR IS RESPONSIBLE FOR INSURING THAT THIS PROJECT AND RELATED WORK COMPLIES WITH ALL APPLICABLE LOCAL, STATE AND FEDERAL SAFETY CODES AND REGULATIONS GOVERNING THIS WORK.

 ALL WORK SHALL BE COMPLETED IN ACCORDANCE WITH THE LATEST EDITION OF THE LOCAL BUILDING CODE.

10. ALL PROPOSED CELLULAR EQUIPMENT AND FIXTURES SHALL BE FURNISHED BY OWNER FOR INSTALLATION BY THE CONTRACTOR, UNLESS SPECIFICALLY NOTED OTHERWISE HEREIN.

11. ACCESS TO THE PROPOSED WORK SITE MAY BE RESTRICTED. THE CONTRACTOR SHALL COORDINATE INTENDED CONSTRUCTION ACTIVITY, INCLUDING WORK SCHEDULE AND MATERIALS ACCESS WITH THE RESIDENT LEASING AGENT FOR APPROVAL.

12. RADIO EQUIPMENT INSTALLATION SHALL BE IN ACCORDANCE WITH THE MANUFACTURER'S SPECIFICATIONS.

 DESIGN REQUIREMENTS PER LOCAL BUILDING CODE AND THE E1A/TIA-222-G STRUCTURAL STANDARDS FOR STEEL ANTENNAS TOWERS AND SUPPORTING STRUCTURES.

2. STRUCTURAL STEEL SHALL CONFORM TO THE LATEST EDITION OF A.I.S.C. SPECIFICATIONS FOR STRUCTURAL STEEL BUILDINGS—ALLOWABLE STRESS DESIGN AND PLASTIC DESIGN INCLUDING THE COMMENTARY AND THE A.I.S.C. CODE OF STANDARD PRACTICE.

3. STRUCTURAL STEEL PLATES AND SHAPES SHALL CONFORM TO ASTM A36. ALL STRUCTURAL STEEL PIPES SHALL CONFORM TO ASTM A53 GRADE 8. ALL STRUCTURAL STEEL TUBING SHALL CONFORM TO ASTM A500 GRACE 8. ALL STRUCTURAL STEEL COMPONENTS AND FABRICATED ASSEMBLIES SHALL BE HOT DIP GALVANIZED AFTER FABRICATION.

4. WELDING SHALL BE IN ACCORDANCE WITH THE AMERICAN WELDING SOCIETY (AWS) D.1.1—96. STRUCTURAL WELDING CODE—STEEL WELD ELECTRODES SHALL BE E70XX.

5. ALL COAXIAL CABLE CONNECTORS AND TRANSMITTER EQUIPMENT SHALL BE AS SPECIFIED BY THE OWNER AND IS NOT INCLUDED IN THESE CONSTRUCTION DOCUMENTS. THE CONTRACTOR SHALL FURNISH ALL CONNECTION HARDWARE REQUIRED TO SECURE THE CABLES. CONNECTION HARDWARE SHALL BE STAINLESS STEEL.

6. NORTH ARROW SHOWN ON PLANS REFERS TO TRUE NORTH.
CONTRACTOR SHALL VERIFY NORTH AND INFORM OWNER OF
ANY DISCREPANCY BEFORE STARTING CONSTRUCTION.

7. ALL CAST IN PLACE CONCRETE SHALL BE MIXED AND PLACED IN ACCORDANCE WITH THE REQUIREMENTS OF ACI 318 AND ACI 301, AND SHALL HAVE A 28 DAY MINIMUM COMPRESSIVE STRENGTH OF 4000 PSI (U.O.N.). CONCRETE SHALL BE PLACED AGAINST UNDISTURBED SOIL UNLESS OTHERWISE NOTED. MINIMUM CONCRETE COVER SHALL BE 3 INCHES UNLESS OTHERWISE NOTED.

8. ALL REINFORCING STEEL SHALL CONFORM TO ASTM 615

ALL REINFORCING STEEL SHALL CONFORM TO ASIM 615
GRADE 80, DEFORMED BILLET STEEL BARS. WELDED WIRE
FABRIC REINFORCING SHALL CONFORM TO ASIM A185.
 THE FABRICATION AND ERECTION OF STRUCTURAL STEEL

SHALL CONFORM TO THE LATEST A.I.S.C. SPECIFICATIONS.

10. ALL CONNECTIONS NOT FULLY DETAILED ON THESE PLANS SHALL BE DETAILED BY THE STEEL FABRICATOR IN

ACCORDANCE WITH A.I.S.C. SPECIFICATIONS.

11. HOT-DIP GALVANIZE ITEMS SPECIFIED TO BE ZINC-COATED. AFTER FABRICATION WHERE PRACTICAL. GALVANIZING: ASTM A 123, ASTM A 153/A 153M OR ASTM A 653/A 653M, G90, AS APPLICABLE.

12. REPAIR DAMAGED SURFACES WITH GALVANIZING REPAIR
METHOD AND PAINT' CONFORMING TO ASTM A 780 OR BY
APPLICATION OF STICK OR THICK PASTE MATERIAL
SPECIFICALLY DESIGNED FOR REPAIR OF GALVANIZING. CLEAN
AREAS TO BE REPAIRED, AND REMOVE SLAG FROM WELDS.
HEAT SURFACES TO WHICH STICK OR PASTE MATERIAL IS
APPLIED WITH A TORCH TO A TEMPERATURE SUFFICIENT TO
MELT THE METALLICS. IN STICK OR PASTE, SPREAD MOLTEN
MATERIAL UNIFORMLY OVER SURFACES TO BE COATED AND
WIPF OFF EXCESS MATERIAL.

13. CONTRACTOR SHALL FOLLOW THE MANUFACTURER'S INSTRUCTIONS/ SPECIFICATIONS IF NO INFORMATION IS CONTAINED IN THESE PLANS OR IF THE MANUFACTURER'S SPECIFICATIONS ARE STRICTER.

PERMITS

 CONTRACTOR SHALL SECURE ALL NECESSARY PERMITS FOR THIS PROJECT FROM ALL APPLICABLE GOVERNMENTAL AGENCIES. (NOT SUPPLIED BY OWNER)

2. ANY PERMITS WHICH MUST BE OBTAINED SHALL BE THE CONTRACTORS RESPONSIBILITY. THE CONTRACTOR SHALL BE RESPONSIBLE FOR ABIDING BY ALL CONDITIONS AND REQUIREMENTS OF THE PERMITS. (NOT SUPPLIED BY OWNER)

 ALL WORK SHALL BE IN ACCORDANCE WITH LOCAL CODES AND THE LATEST APPLICABLE CODES AND STANDARDS.

 THE CONTRACTOR SHALL NOTIFY THE APPLICABLE JURISDICTIONAL (STATE, COUNTY, OR CITY) ENGINEER 24 HOURS PRIOR TO THE BEGINNING OF CONSTRUCTION.

5, CONTRACTOR RESPONSIBLE FOR CLOSING AND FILING ALL PERMITS ASSOCIATED WITH SITE.

1. CONTRACTOR SHALL CONTACT A SUBSURFACE UTILITY
LOCATOR FOR LOCATION OF EXISTING UTILITIES PRIOR TO
COMMENCEMENT OF ANY CONSTRUCTION ACTIVITIES.
LOCATION OF EXISTING SEWER, WATER LINES, GAS LINES,
CONDUITS OR OTHER STRUCTURES ACROSS, UNDERNEATH, OR
OTHERWISE ALONG THE LINE OF PROPOSED WORK ARE NOT
NECESSARILY SHOWN ON THE PLANS, AND IF SHOWN ARE
ONLY APPROXIMATELY CORRECT. CONTRACTOR ASSUMES SOLE
RESPONSIBILITY FOR VERIFYING LOCATION AND ELEVATION OF
ALL UNDERGROUND UTILITIES (INCLUDING TEST PITS BY HAND
IF NECESSARY) IN AREAS OF CONSTRUCTION PRIOR TO
STARTING WORK. CONTACT ENGINEER IMMEDIATELY IF LOCATION
DR ELEVATION IS DIFFERENT FROM THAT SHOWN ON THE
PLANS. OR IF THERE APPEARS TO BE A CONFLICT.

 CONTRACTOR SHALL COORDINATE ALL UTILITY CONNECTIONS WITH APPROPRIATE UTILITY OWNERS AND CONSTRUCTION MANAGER.

3. DAMAGE BY THE CONTRACTOR TO UTILITIES OR PROPERTY OF OTHERS, INCLUDING EXISTING PAVEMENT AND OTHER SURFACES DISTURBED BY THE CONTRACTOR DURING CONSTRUCTION SHALL BE REPAIRED TO PRE CONSTRUCTION CONDITIONS BY THE CONTRACTOR AT NO ADDITIONAL COST TO THE CLIENT. FOR GRASSED AREAS, SEED AND MULCH SHALL BE ACCEPTABLE.

4. THE CONTRACTOR SHALL COORDINATE WITH THE OWNER THE REQUIREMENTS FOR AND LIMITS OF OVERHEAD AND/OR UNDERGROUND ELECTRICAL SERVICE.

5. THE CONTRACTOR SHALL COORDINATE THE LOCATION OF NEW UNDERGROUND TELEPHONE SERVICE WITH THE TELEPHONE UTILITY AND THE OWNER'S REQUIREMENTS.

6. ALL UNDERGROUND UTILITIES SHALL BE INSTALLED AND TESTED SATISFACTORY PRIOR TO COMMENCING ANY PAVING OPERATIONS WHERE SUCH UTILITIES ARE WITHIN THE LIMITS OF PAVEMENT.

GRADING

1. THE CONTRACTOR SHALL REWORK (DRY, SCARIFY, ETC...) ALL MATERIAL NOT SUITABLE FOR SUB GRADE IN ITS PRESENT STATE. IF THE MATERIAL, AFTER REWORKING, REMAINS UNSUITABLE THEN THE CONTRACTOR SHALL UNDERCUT THIS MATERIAL AND REPLACE WITH APPROVED MATERIAL AT HIS EXPENSE. ALL SUB GRADES SHALL BE PROOF ROLLED WITH A FULLY LOADED TANDEM AXLE DUMP TRUCK PRIOR TO PAVING. ANY SOFT MATERIAL SHALL BE REWORKED OR REPLACED.

2. THE CONTRACTOR IS REQUIRED TO MAINTAIN ALL DITCHES, PIPES, AND OTHER DRAINAGE STRUCTURES FREE FROM OBSTRUCTION UNTIL WORK IS ACCEPTABLE BY THE OWNER. THE CONTRACTOR IS RESPONSIBLE FOR ANY DAMAGES CAUSED BY FAILURE TO MAINTAIN DRAINAGE STRUCTURES IN OPERABLE CONDITION.

ALL MATERIALS AND WORKMANSHIP SHALL BE WARRANTED FOR ONE (1) YEAR FROM DATE OF ACCEPTANCE.

4. ALL DIMENSIONS SHALL BE VERIFIED WITH THE PLANS (LATEST REVISION) PRIOR TO COMMENCING CONSTRUCTION. NOTIFY THE OWNER IMMEDIATELY IF DISCREPANCIES ARE DISCOVERED. THE CONTRACTOR SHALL HAVE A SET OF APPROVED PLANS AVAILABLE AT THE SITE AT ALL TIMES WHEN WORK IS BEING PRE FORMED. A DESIGNATED RESPONSIBLE EMPLOYEE SHALL BE AVAILABLE FOR CONTACT BY GOVERNING AGENCY INSPECTORS.

 AWARDED CONTRACTOR WILL BE REQUIRED TO SIGN AND RETURN A COPY OF AN AWARD LETTER FOR SBA'S FILE.

 CONTRACTOR WILL BE REQUIRED TO PROVIDE PROOF OF LICENSE TO PERFORM WORK IN JURISDICTION AT TIME OF BID AWARD.

3. CONTRACTOR WILL PROVIDE A CONSTRUCTION SCHEDULE PRIOR TO CONSTRUCTION STARTING AND WILL PROVIDE UPDATE/CHANGES (WITH EXPLANATIONS) TO THAT SCHEDULE WHEN/IF ITEMS ARE DELAYED OR PUSHED OUT.

 CONTRACTOR WILL BE RESPONSIBLE FOR ALL CONCRETE COMPRESSIVE TESTING AND REQUIRED TO SUBMIT FINAL TEST RESULTS WITH CLOSE OUT BOOK.

5. CONTRACTOR WILL BE RESPONSIBLE TO PROVIDE SBA PROJECT MANAGERS WITH PHOTOS OF THE MAJOR CONSTRUCTION MILESTONES AS THEY OCCUR.

6. CONTRACTOR WILL BE RESPONSIBLE TO ASSIST IN COORDINATING AND OBTAINING PRIMARY POWER TO THE SITE PRIOR TO TOWER ERECTION, AS WELL AS TELCO SERVICE BEFORE PROJECT COMPLETION. (ON SITE VISITS WITH UTILITY COMPANY REPRESENTATIVES AS NECESSARY, ETC....).

CONTRACTOR WILL HAVE A REPRESENTATIVE ON A WEEKLY CONFERENCE CALL TO PROVIDE SBA WITH SITE SPECIFIC UPDATES. CURRENTLY, THIS CONFERENCE CALL IS HELD EACH AND EVERY THURSDAY AT 4 PM (EASTERN TIME).

8. CONTRACTOR SHOULD BE PREPARED FOR RANDOM SBA SAFETY INSPECTIONS AT ALL TIMES.

 CONTRACTOR IS EXPECTED TO MAINTAIN PROPER WORKING CONDITIONS AND PROCEDURES PER OSHA STANDARDS AT ALL TIMES.

 CONTRACTOR WILL BE REQUIRED TO OBTAIN THE NECESSARY ELECTRICAL PERMITS AND INSPECTIONS AS REQUIRED BY JURISDICTION.

 CONTRACTOR IS EXPECTED TO CLOSE—OUT THE JOB SITE AS QUICKLY AS POSSIBLE (OBTAINING A CERTIFICATE OF OCCUPANCY AND GETTING SBA'S REGIONAL SITE MANAGER'S SIGN—OFF/CHECKLIST APPROVAL ON THE SITE).

SIGN-OFF/CHECKLIST APPROVAL ON THE SITE).
2. CONTRACTOR WILL PROVIDE A COMPLETED TOWER HEIGHT VERIFICATION FORM AND TAPE DROP WITHIN 24 HOURS OF REACHING OVERALL HEIGHT.

13. CONTRACTOR WILL UTILIZE ALL OF THE SBA PROVIDED DOCUMENTATION INCLUDING BUT NOT LIMITED TO: TOWER CONSTRUCTION ACCEPTANCE CHECKLIST, CONSTRUCTION SCHEDULE, CONSTRUCTION CLOSE—OUT LIST & TOWER HEIGHT VERIFICATION.

14. CONTRACTOR IS RESPONSIBLE FOR CONCRETE COMPRESSION

15. CONTRACTOR IS RESPONSIBLE FOR GROUND MEG TESTING.
 16. CONTRACTOR IS RESPONSIBLE FOR ALL GRADING AND FILL COMPACTION TESTING REQUIRED AS SET FORTH IN THE GEO

TECHNOLOGICAL REPORT PROVIDED BY OWNER.



SBA NETWORK SERVICES, LLC. 8051 CONGRESS AVENUE BOCA RATON, FL 33487 TEL: (800) 487-7483



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A&E PROJECT#:	241149118
DRAWN BY:	JDS
CHECKED BY:	SM
REV. 1 BY:	VJS

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- 1	10	10/31/24	ISSUED FOR REVIEW
- 1	NO.	DATE	DESCRIPTION
- 1	=		



SITE NAME:

MT JULIET

TE NUMBER:

TN29593-S

300 PLEASANT GROVE ROAD, SUITE 600 MOUNT JULIET, TN 37122

RAWLAND

SHEET TITLE:

GENERAL NOTES

SHEET NUMBER:

| 1

GEOTECHNICAL NOTES

- THE SITE SHALL BE CLEARED BY MEANS OF REMOVING TREES, TREE STUMPS, SURFACE VEGETATION AND TOPSOIL MATERIALS. IT'S RECOMMENDED THAT CLEARING EXTEND AT LEAST 5 FEET BEYOND PLANNED BUILDING AREAS AND AREAS TO RECEIVE COMPACTED FILL. IN PREPARATION FOR FILL PLACEMENT, AREAS SHALL BE LEVELED OUT TO FACILITATE THE PLACEMENT OF FILL IN HORIZONTAL LIFTS. THIS SHALL BE ACHIEVED BY CUTTING INTO THE UPHILL SIDE OF AREAS TO RECEIVE FILL, AREAS TO RECEIVE FILL SHALL BE EVALUATED BY A GEOTECHNICAL ENGINEER TO VERIFY THAT THEY ARE IN FIRM, RELATIVELY DRY AND SUITABLE FOR FILL PLACEMENT.
- 2. WITH THE EXCEPTION OF THE UPPER 2 FEET BENEATH PLANNED FOUNDATIONS AND BUILDING PADS, FILL MATERIALS SHALL BE COMPACTED TO AT LEAST 95 PERCENT OF THE MAXIMUM DRY DENSITY AS DETERMINED BY THE STANDARD PROCTOR METHOD (ASTM D-698). FILL WITHIN THE UPPER 2 FEET BENEATH PLANNED FOUNDATIONS AND BUILDING PADS SHALL BE COMPACTED TO AT LEAST 98% OF THE MAXIMUM DRY DENSITY AS DETERMINED BY THE STANDARD PROCTOR METHOD (ASTM D-698).
- 3. TO ACCOMPLISH THIS, IT IS RECOMMENDED THAT FILL SOIL MOISTURE CONTENTS BE MAINTAINED WITHIN 3 PERCENTAGE POINTS OF THE OPTIMUM MOISTURE CONTENT AS DETERMINED BY THE STANDARD PROCTOR METHOD (ASTM D698), SOILS WITH EXCESSIVE MOISTURE SHALL BE SCARIFIED, DISCED, AND DRIED DURING THE WARMER DRYER MONTHS TO REDUCE THE MOISTURE CONTENT, AND MOISTURE SHALL BE ADDED TO INCREASE THE MOISTURE CONTENT.
- 4. TO ACHIEVE PROPER COMPACTION, SUITABLE MOISTURE CONDITIONED FILL MATERIALS SHALL BE PLACED IN HORIZONTAL LOOSE LIFTS (8 INCHES LOOSE IF LARGE COMPACTION EQUIPMENT IS USED, 4 INCHES IF SMALLER WALK—BEHIND EQUIPMENT IS TO BE USED). IF SANDY SOILS ARE ENCOUNTERED COMPACTION WITH A HEAVY SMOOTH DRUM SHALL BE USED. IF CLAY OR SILT SOILS ARE ENCOUNTERED A SHEEPSFOOT ROLLER SHALL BE MORE EFFECTIVE ACHIEVING
- 5. IN-PLACE DENSITY TESTS SHALL BE PERFORMED TO VERIFY COMPACTION OF THE FILL MATERIALS. THESE TESTS ARE GENERALLY PERFORMED AT A FREQUENCY OF ONE TEST PER 2,500 SQUARE FEET AND ON EACH FOOT OF FILL BEING
- 6. FOUNDATIONS FOR LIGHTLY LOADED STRUCTURES (IE. GENERATORS AND EQUIPMENT SHELTERS) SHALL BE DESIGNED TO BEAR IN THE NEWLY PLACED, COMPACTED FILL. FOUNDATIONS FOR LIGHTLY LOADED STRUCTURES SET IN FILL SHALL BE DESIGNED TO BEAR AT LEAST 2 FEET BELOW THE FINISHED GROUND SURFACE, TO HAVE A MINIMUM FOOTING WIDTH OF 1B INCHES, AND WITH A GROSS ULTIMATE BEARING PRESSURE OF 6000 PSF, PROVIDED THAT FILL MATERIALS ARE VERIFIED AS BEING SUITABLE, AND COMPACTED AS RECOMMENDED IN THESE NOTES.



SBA NETWORK SERVICES, LLC. 8051 CONGRESS AVENUE BOCA RATON, FL 33487 TEL: (800) 487-7483

201 NORTH FRANKLIN STREET SUITE 1400 TAMPA, FL 33602 PHONE (813) 620-1460 WWW.KIMLEY-HORN.COM

THE INFORMATION CONTAINED IN THIS SET OF DOCUMENTS IS PROPRIETARY BY NATURE, ANY USE OR DISCLOSURE OTHER THAN THAT WHICH RELATES
TO THE CLIENT IS STRICTLY PROHIBITED.

-10	A&E PROJECT#:	241149118
Ш	DRAWN BY:	JDS
Ш	CHECKED BY:	SM
Ш	REV. 1 BY:	VJS

	R	EVISIONS
	_	
Δ	11/26/24	ISSUED FOR CONSTRUCTION
10	10/31/24	ISSUED FOR REVIEW
NO.	DATE	DESCRIPTION



SITE NAME:

MT JULIET

TN29593-S

TE ADDRESS: 300 PLEASANT GROVE ROAD, SUITE 600 MOUNT JULIET, TN 37122


RAWLAND

GENERAL NOTES

REVISION

GN-2

PARENT PARCEL DETAIL

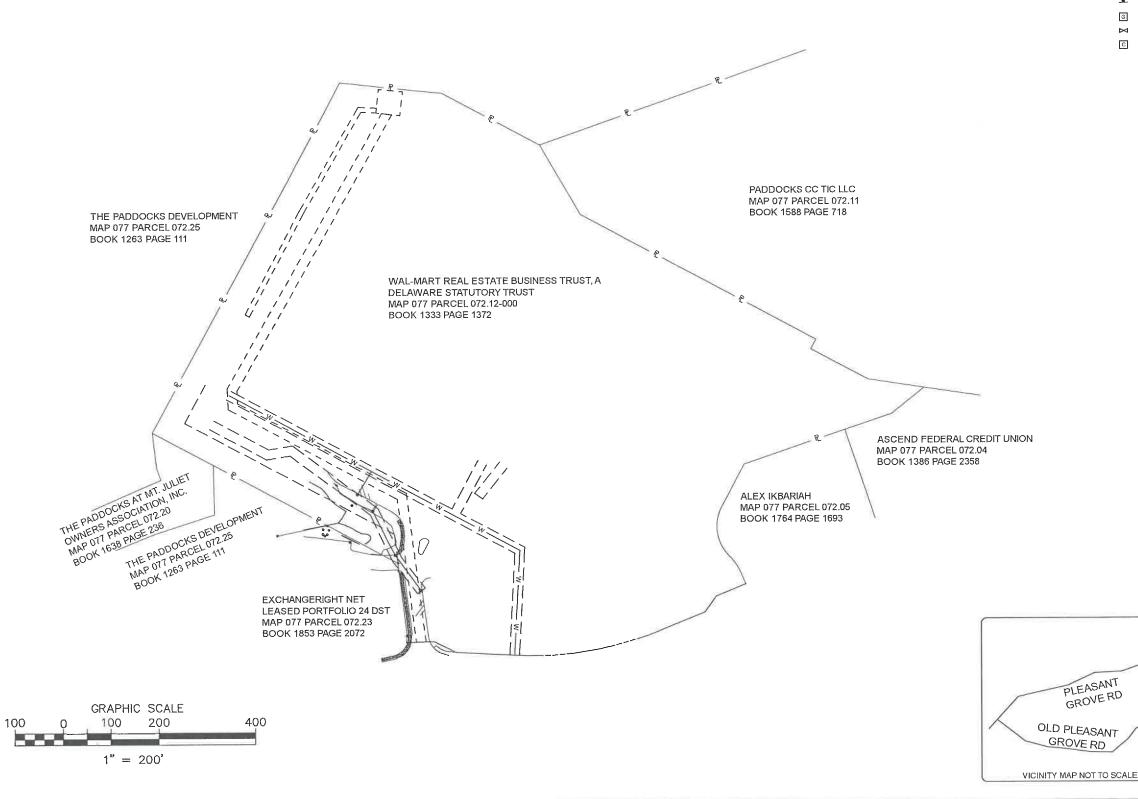

LEGEND

© :COMMUNICATION BOX

N MT JULIET RD

Ф	:MAG NAIL (FOUND)	P.O.B.	:POINT OF BEGINNING
	:IRON PIN (FOUND)	P.O.C.	:POINT OF COMMENCEMENT
6	:STORM MANHOLE	R.O.W.	:RIGHT-OF-WAY
0	:BOLLARD	C.M.P.	:CORRUGATED METAL PIPE
tion con	:DROP INLET	x	:FENCE AS NOTED
(6)	:SEWER MANHOLE	st	:UNDERGROND STORM LINE
J	:FIRE HYDRANT	e	:CENTERLINE
ø	:POWER POLE		:PARENT PARCEL LINE
+0+	:AREA LIGHT	RW	:RIGHT-OF-WAY LINE
	:SIGN POST		:EASEMENT LINE
G	:GAS METER		:CONTOUR LINE
\bowtie	:WATER VALVE	EU	:UNDERGROUND ELECTRIC LIN

AS-BUILT SURVEY

WILSON COUNTY, TN TAX ID: 077 072.12

SBA SITE #: TN29593-S SITE NAME: WM 4482 MT. JULIET TN ADDRESS:

300 PLEASANT GROVE RD. STE 600 MT. JULIET, TN 37122



SBA NETWORK SERVICES, LLC 8051 CONGRESS AVE. BOCA RATON, FL 33487

SURVEYOR'S CERTIFICATION I HEREBY CERTIFY TO: SBA TOWERS X, LLC, A DELAWARE LIMITED LIABILITY COMPANY AND FIDELITY NATIONAL TITLE INSURANCE COMPANY, TITLE COMMITMENT NO. 5000001720, EFFECTIVE DATE 10-10-23



SURVEY WORK PERFORMED BY:




1198 OLD PINNACLE RD. JOELTON, TN 37080


NATIONAL SURVEYING SERVICES COORDINATED BY:

GEGLINE Surveying, Inc

SURVEYING, INC. 13430 NW 104th Terrace, Suite A, Alachua, FL 32615 Office:(386) 418-0500 Fax:(386) 462-9986 WWW.GEOLINEINC.COM

SHEET 1 OF 4

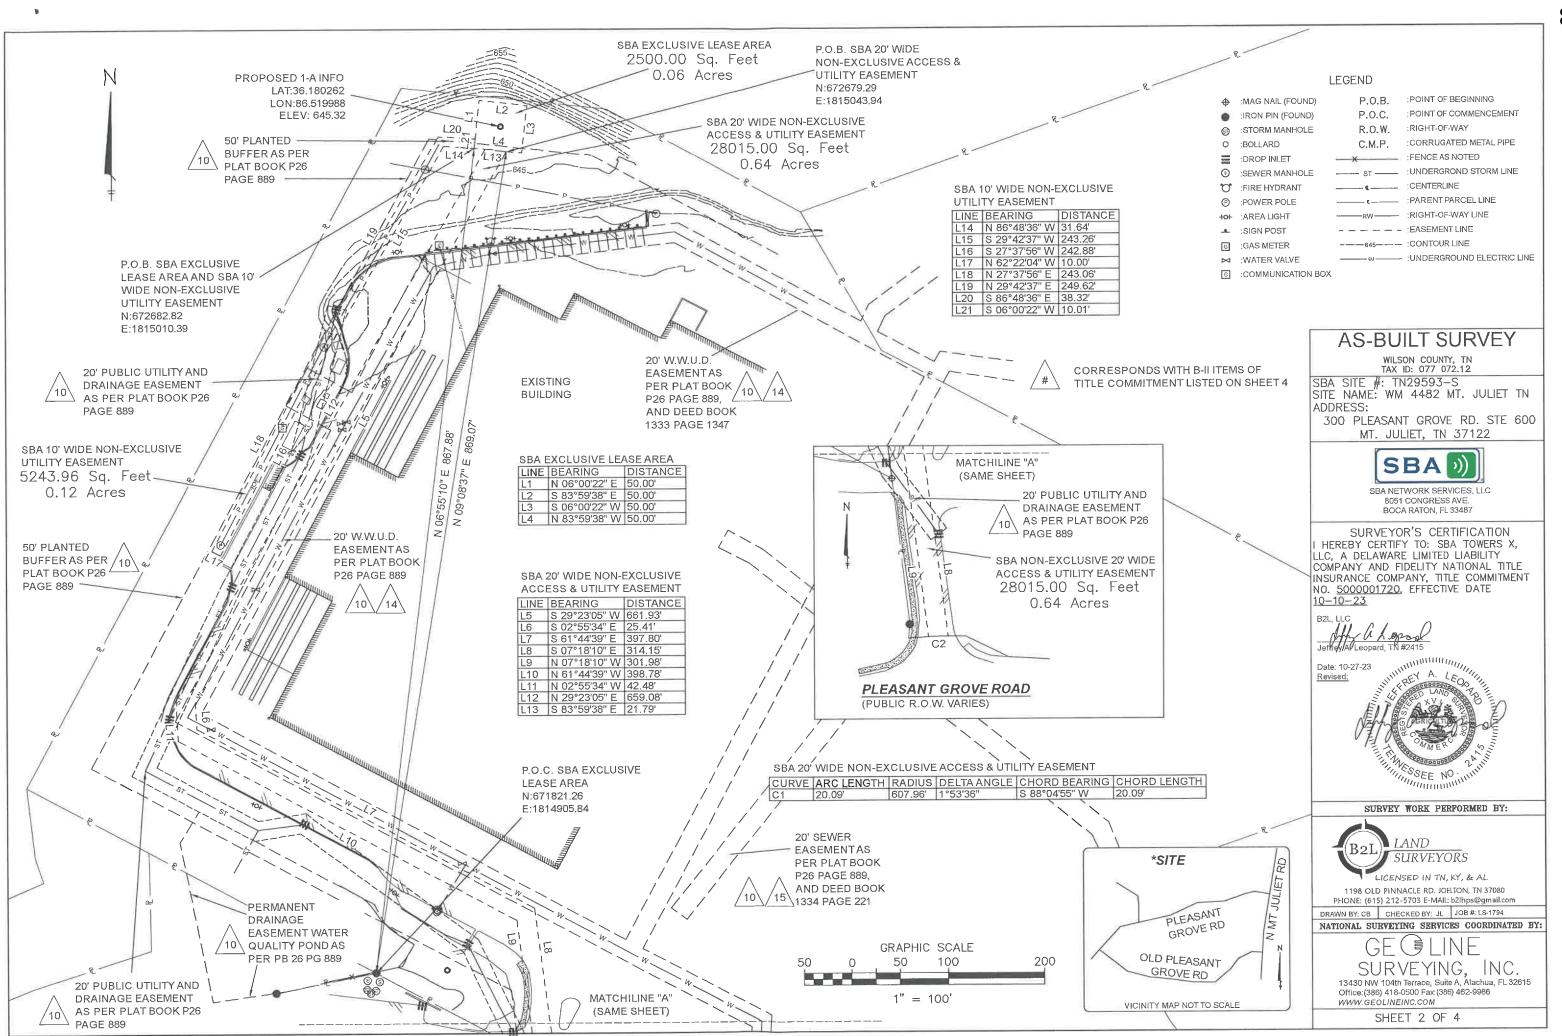

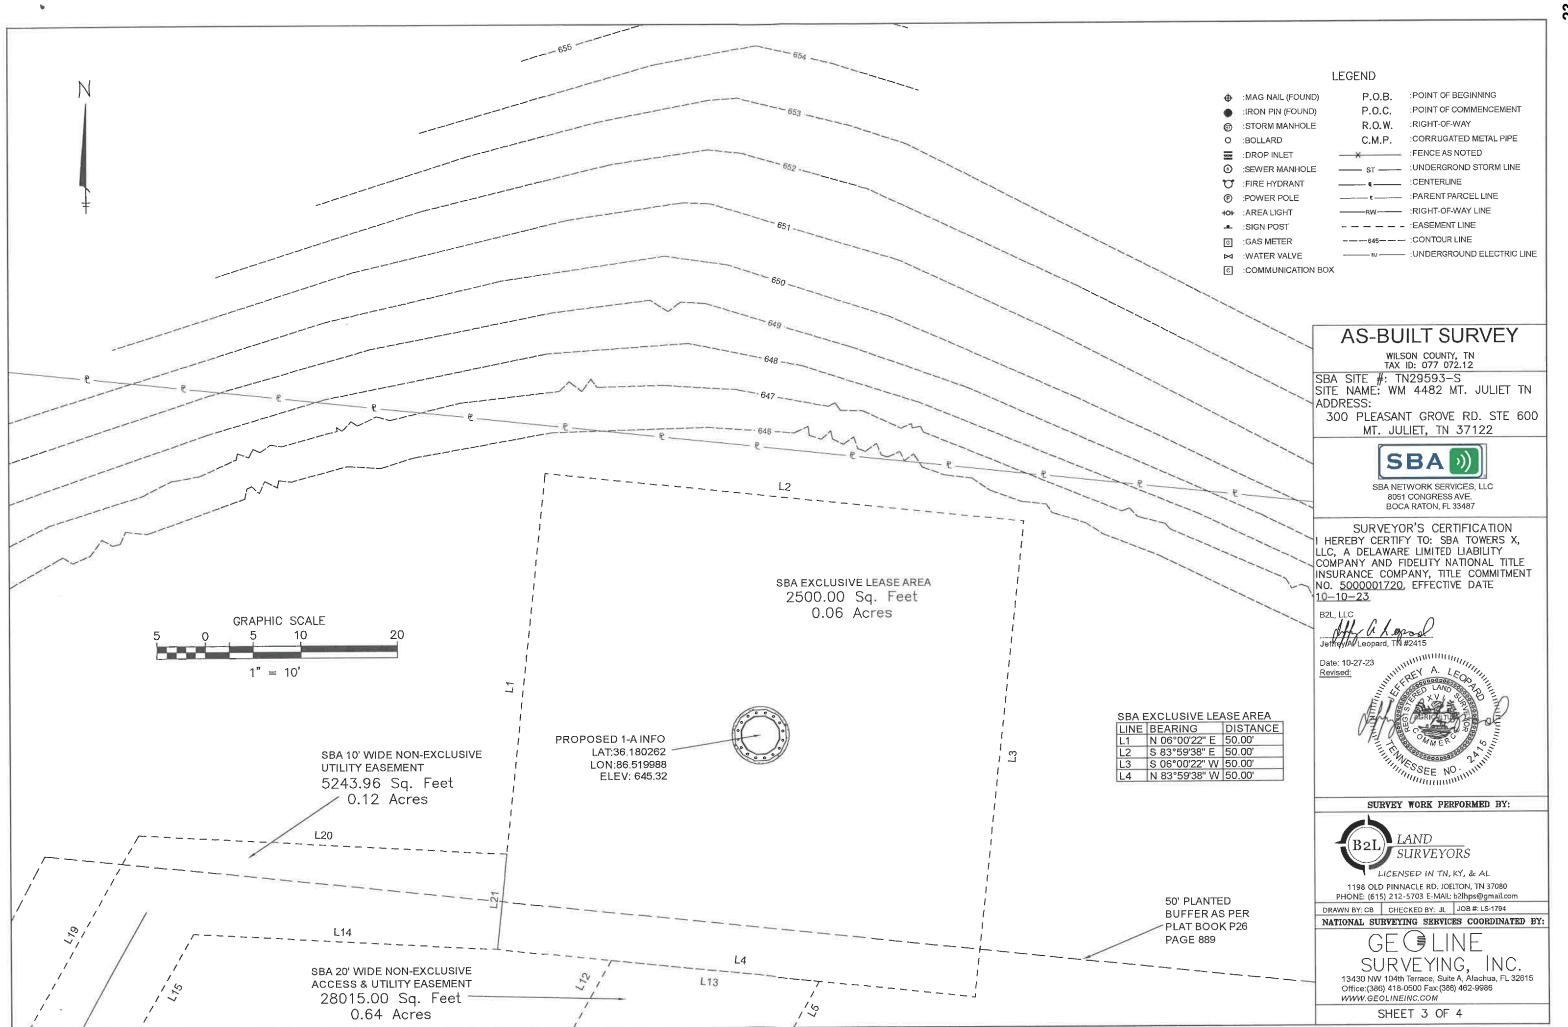

EXCLUSIVE LEASE AREA LEGAL DESCRIPTION (AS SURVEYED)

Situated in Wilson County, Tennessee, and being more particularly described as follows:

COMMENCING at an iron (found) in the northerly line of the Exchangeright Net Leased Portfolio 24 DST property (Book 1853 Page 2072), located at Tennessee State Plane Coordinates N: 671821.26 E: 1814905.84, thence. North 06 degrees 55 minutes 10 seconds East, 867.88 feet to Tennessee State Plane Coordinates N: 672682.82 E: 1815010.39, this being the TRUE POINT OF BEGINNING:

Thence, North 06 degrees 00 minutes 22 seconds East, 50.00 feet;

Thence, South 83 degrees 59 minutes 38 seconds East, 50.00 feet;

Thence, South 06 degrees 00 minutes 22 seconds West 50.00 feet;

Thence, North 83 degrees 59 minutes 38 seconds West, 50.00 feet to the POINT OF BEGINNING. Containing 2,500.00 square feet or 0.06 acres, more or less.

OWNER: WAL-MART REAL ESTATE BUSINESS TRUST, A DELAWARE STATUTORY TRUST PARCEL ID: MAP 077 PARCEL 072.12-000

20' WIDE NON-EXCLUSIVE ACCESS & UTILITY EASEMENT LEGAL DESCRIPTION (AS SURVEYED)

DEED REFERENCE: BOOK 1333 PAGE 1372

Situated in Wilson County, Tennessee, and being more particularly described as follows:

COMMENCING at an iron (found) in the northerly line of the Exchangeright Net Leased Portfolio 24 DST property (Book 1853 Page 2072), located at Tennessee State Plane Coordinates N: 671821.26 E: 1814905.84, thence, North 55 degrees 23 minutes 48 seconds East, 69.77 feet to Tennessee State Plane Coordinates N: 671860.88 E: 1814963.26, this being the TRUE POINT OF BEGINNING;

Thence, South 29 degrees 23 minutes 05 seconds West, 661.93 feet;

Thence, South 02 degrees 55 minutes 34 seconds East, 25.41 feet;

Thence, South 61 degrees 44 minutes 39 seconds East, 397.80 feet;

Thence, South 07 degrees 18 minutes 10 seconds East, 314.15 feet;

Thence, with a curve to the left, having an arc length of 20.09 feet, a radius of 607.96 feet, a chord bearing of South 88 degrees 04 minutes 55 seconds West, a chord length of 20.08 feet;

Thence, North 07 degrees 18 minutes 10 seconds West 301.98 feet;

Thence, North 61 degrees 44 minutes 39 seconds West, 398.78 feet;

Thence, North 02 degrees 55 minutes 34 seconds West, 42.48 feet;

Thence, North 29 degrees 23 minutes 05 seconds East, 659.08 feet;

Thence, South 83 degrees 59 minutes 38 seconds East, 21.79 feet to the POINT OF BEGINNING. Containing 28,015.00 square feet or 0.64 acres, more or less.

OWNER: WAL-MART REAL ESTATE BUSINESS TRUST, A DELAWARE STATUTORY TRUST PARCEL ID: MAP 077 PARCEL 072.12-000 DEED REFERENCE: BOOK 1333 PAGE 1372

10' WIDE NON-EXCLUSIVE UTILITY EASEMENT LEGAL DESCRIPTION (AS SURVEYED)

Situated in Wilson County, Tennessee, and being more particularly described as follows:

COMMENCING at an iron (found) in the northerly line of the Exchangeright Net Leased Portfolio 24 DST property (Book 1853 Page 2072), located at Tennessee State Plane Coordinates N: 671821.26 E: 1814905.84, thence, North 06 degrees 55 minutes 10 seconds East, 867.88 feet to Tennessee State Plane Coordinates N: 672682.82 E: 1815010.39, this being the TRUE POINT OF BEGINNING:

Thence, North 86 degrees 48 minutes 36 seconds West, 31.64 feet;

Thence, South 29 degrees 42 minutes 37 seconds West, 243.26 feet;

Thence, South 27 degrees 37 minutes 56 seconds West 242.88 feet;

Thence, North 62 degrees 22 minutes 04 seconds West, 10.00 feet;

Thence, North 27 degrees 37 minutes 56 seconds East, 243.06 feet;

Thence, North 29 degrees 42 minutes 37 seconds East, 249.62 feet;

Thence, South 86 degrees 48 minutes 36 seconds East, 38.32 feet;

Thence, South 06 degrees 00 minutes 22 seconds West, 10.01 feet to the POINT OF BEGINNING. Containing 5,243.96 square feet or 0.12 acres, more or less.

OWNER: WAL-MART REAL ESTATE BUSINESS TRUST, A DELAWARE STATUTORY TRUST PARCEL ID: MAP 077 PARCEL 072.12-000 DEED REFERENCE: BOOK 1333 PAGE 1372

PARENT PARCEL LEGAL DESCRIPTION (AS PROVIDED)

An interest in land, said interest being over a portion of the following described parent parcel:

A tract of land lying in the 25th Civil District of Mt. Juliet, Wilson County, Tennessee, being Lot No. 12 on the Final Plat of The Paddocks at Mt. Juliet, Phase I, which plat is of record in Plat Book P26, Page 889, Register's Office for Wilson County, Tennessee.

AND BEING the same property conveyed to Wal-Mart Real Estate Business Trust, a Delaware statutory trust from The Paddocks Development, L.P., a Delaware limited partnership by Special Warranty Deed dated December 19, 2008 and recorded January 14, 2009 in Deed Book 1333, Page 1372.

Tax Parcel No. 077-072.12-000

TITLE INSURANCE COMMITMENT NOTE:

I HAVE REVIEWED COMMITMENT FOR TITLE INSURANCE, UNDERWRITTEN BY FIDELITY NATIONAL TITLE INSURANCE COMPANY, WITH AN EFFECTIVE DATE OF OCTOBER 10, 2023 COMMITMENT NUMBER 5000001720, AND FIND AS FOLLOWS WITH RESPECT TO THE EXCEPTIONS LISTED IN SCHEDULE B-SECTION 2 OF SAID COMMITMENT:

ITEMS 1-7 ARE STANDARD EXCEPTIONS AND ARE NOT THE TYPE TO BE DEPICTED HEREON.

8. Matters as shown and noted on Plat recorded in Plat Book P25, Page 967. (APPARENTLY VOIDED, VACATED, AND SUPERSEDED BY SUBSEQUENT PLATS) 9, Matters as shown and noted on Plat recorded in Plat Book P25, Page 968. APPARENTLY VOIDED, VACATED, AND SUPERSEDED BY SUBSEQUENT PLATS) 10. Matters as shown and noted on Plat recorded in Plat Book P26, Page 889. (AFFECTS PARENT PARCEL, ALL MATTERS SHOWN HEREON)

11. Storm Water Maintenance Agreement dated September 27, 2007, by and between The Paddocks Development, LP and The City of Mt. Juliet, recorded on October 10, 2007 in Deed Book 1274, Page 1812. (BLANKET IN NATURE, AFFECTS PARENT PARCEL. NOT THE TYPE TO BE DEPICTED HEREON)

12. Storm Water Detention Agreement dated September 27, 2007, by and between The Paddocks Development, LP and The City of Mt. Juliet, recorded on October 10, 2007 in Deed Book 1274, Page 1816. (BLANKET IN NATURE, AFFECTS PARENT PARCEL. NOT THE TYPE TO BE DEPICTED HEREON)

13. Declaration of Covenants, Conditions and Restrictions for the Paddocks at Mt. Juliet recorded on January 14, 2009 in Deed Book 1333, Page 1291; AMENDED BY First Amendment to Declaration of Covenants, Conditions and Restrictions for the Paddocks at Mt. Juliet recorded on July 23, 2009 in Deed Book 1363, Page 2044; AMENDED BY Second Amendment to Declaration of Covenants, Conditions and Restrictions for the Paddocks at Mt. Juliet recorded on February 10, 2010 in Deed Book 1386, Page 2344; AMENDED BY Third Amendment to Declaration of Covenants. Conditions and Restrictions for the Paddocks at Mt. Juliet recorded on March 9, 2012 in Deed Book 1477, Page 1962; AMENDED BY Fourth Amendment to Declaration of Covenants, Conditions and Restrictions for the Paddocks at Mt. Juliet recorded on March 3, 2015 in Deed Book 1630, Page 1003;

AMENDED BY Fifth Amendment to Declaration of Covenants, Conditions and Restrictions for the Paddocks at Mt. Juliet recorded on September 5, 2019 in Deed Book 1904. Page 47: AMENDED BY Sixth Amendment to Declaration of Covenants, Conditions and Restrictions for the Paddocks at Mt. Juliet recorded on July 7, 2021 in Deed Book 2083, Page 614. (BLANKET IN NATURE, AFFECTS PARENT PARCEL. NOT PLOTTABLE)

14 Easement Agreement in favor of West Wilson Utility District of Wilson County, Tennessee set forth in instrument recorded on January 14, 2009 in Deed Book 1333, Page 1347, (AFFECTS PARENT PARCEL, DOES NOTAFFECT PROPOSED SBA LEASE AREA OR 20' WIDE NON-EXCLUSIVE ACCESS & UTILITY EASEMENT AREA, AS SHOWN HEREON AS SHOWN HEREON)

/15. Agreement for Dedication of a Sanitary Sewer Easement by and between Wal-Mart Real Estate Business Trust, as Grantor, and The City of Mt. Juliet, Tennessee, as Grantee, recorded on January 14, 2009 in Deed Book 1333, Page 1450. (AFFECTS PARENT PARCEL, DOES NOT AFFECT PROPOSED SBA LEASE AREA OR 20' WIDE NON-EXCLUSIVE ACCESS & UTILITY EASEMENT AREA, AS SHOWN HEREON) 16. Performance Bond, by and between Vratsinas Construction Company, Travelers Casualty and Surety Company of America and Wal-Mart Stores, Inc., recorded on January 20, 2009 in Deed Book 1334, Page 221, in the original amount of \$5,835,970.00. (BLANKET IN NATURE, NOT THE TYPE TO BE DEPICTED HEREON)



CORRESPONDS WITH B-II ITEMS OF TITLE COMMITMENT LISTED ON SHEET 2

AS-BUILT SURVEY

WILSON COUNTY, TN TAX ID: 077 072.12

SBA SITE #: TN29593-S SITE NAME: WM 4482 MT, JULIET TN ADDRESS:

300 PLEASANT GROVE RD. STE 600 MT. JULIET, TN 37122



SBA NETWORK SERVICES, LLC 8051 CONGRESS AVE. BOCA RATON, FL 33487

SURVEYOR'S CERTIFICATION HEREBY CERTIFY TO: SBA TOWERS X, LLC. A DELAWARE LIMITED LIABILITY COMPANY AND FIDELITY NATIONAL TITLE INSURANCE COMPANY, TITLE COMMITMENT NO. 5000001720, EFFECTIVE DATE 10-10-23





SURVEY WORK PERFORMED BY:



1198 OLD PINNACLE RD. JOELTON, TN 37080


PHONE: (615) 212-5703 E-MAIL: b2lhps@gmail.com

DRAWN BY: CB CHECKED BY: JL JOB #: LS-1794 NATIONAL SURVEYING SERVICES COORDINATED BY:



13430 NW 104th Terrace, Suite A, Alachua, FL 32615 Office:(386) 418-0500 Fax:(386) 462-9986 WWW.GEOLINEINC.COM

SHEET 4 OF 4

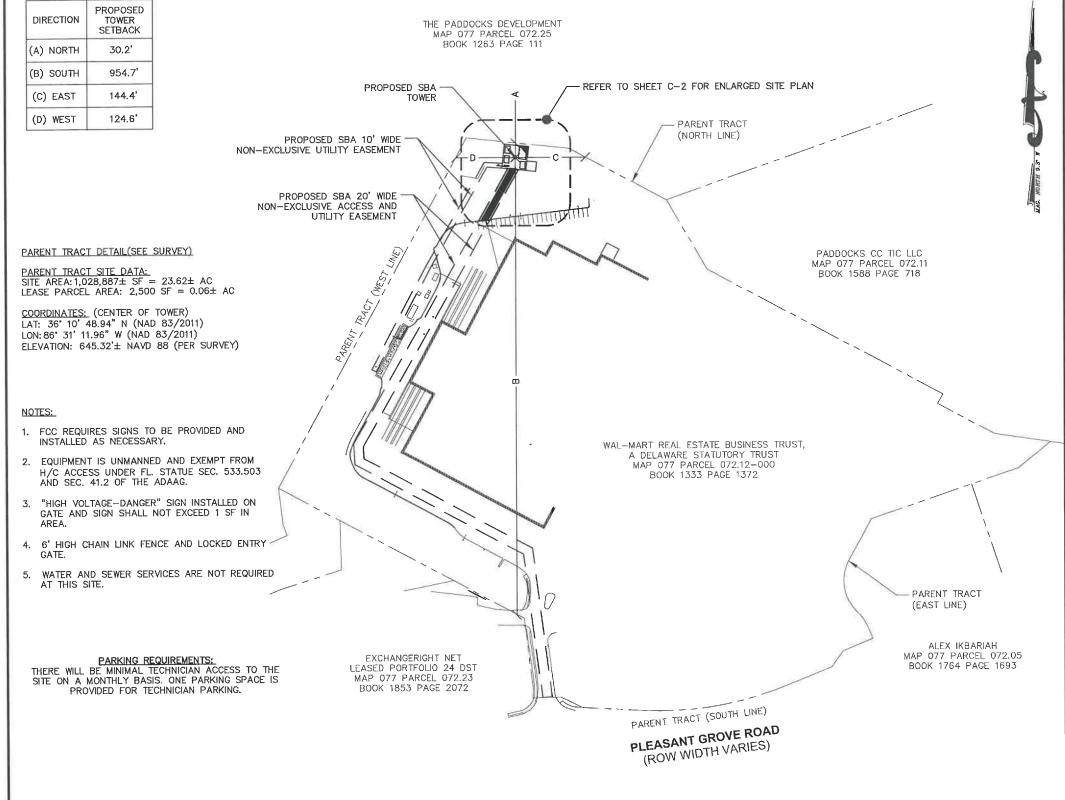

- FENCED SITE AREA SHALL BE CLEARED AND GRUBBED. REMOVE UNSUITABLE SOFT OR LOOSE SOILS, ORGANIC MATERIAL AND OR RUBBLE TO FIRM SUBGRADE. FILL UNDERCUT UP TO 6 INCHES BELOW FINISH GRADE.
- THE CONTRACTOR MUST CONTACT THE SURVEYOR TO STAKE OUT THE LEASE AREA AND ALL EASEMENTS PRIOR TO CONSTRUCTION. ALL FEES ARE THE RESPONSIBILITY OF THE
- IF ANY ARCHAEOLOGICAL MATERIALS ARE ENCOUNTERED DURING CONSTRUCTION, THE CONTRACTOR SHALL STOP WORK IMMEDIATELY AND NOTIFY THE CLIENT.
- THE CONTRACTOR IS TO ENSURE THAT NO DAMAGE OR DEBRIS OCCURS ON THE ADJACENT PROPERTIES.
- THE CONTRACTOR SHALL SEED ALL DISTURBED AREAS WITH LOW MAINTENANCE NATIVE GRASS AND COVER WITH APPROVED STRAW.
- UNTIL THE COMPOUND IS SURROUNDED BY A PERMANENT FENCE, THE CONTRACTOR MUST ERECT A TEMPORARY FENCE AROUND THE TOWER AND POST A "NO TRESPASSING" SIGN. ALL CLIMBING PEGS MUST BE REMOVED UP TO 20' UNTIL A PERMANENT FENCE IS INSTALLED.
- THE CONTRACTOR MUST ENSURE THAT ALL DELIVERY TRUCKS WILL BE ABLE TO DELIVER THE MATERIAL TO THE COMPOUND. IF THE DELIVERY TRUCKS CAN NOT ACCESS THE COMPOUND THEN THE CONTRACTOR MUST MAKE OTHER ARRANGEMENTS TO GET THE MATERIAL TO THE COMPOUND. IF THIS IS REQUIRED THE CONTRACTOR MUST CONTACT KIMLEY-HORN AND ASSOCIATES IMMEDIATELY. NO ADDITIONAL FEES WILL BE PASSED ON TO THE CLIENT.
- PROPOSED TOWER AND FOUNDATION TO BE INSTALLED IN ACCORDANCE WITH THE TOWER MANUFACTURER PLANS PROVIDED BY CLIENT, THE CONTRACTOR SHALL BE RESPONSIBLE FOR THE UNLOADING OF TOWER MATERIALS DELIVERED TO SITE BY THE TOWER MANUFACTURER.
- CONTRACTOR MUST REFER TO THE GEOTECH REPORT FOR ALL COMPACTED FILL RECOMMENDATIONS. IF THE GEOTECH REPORT CONFLICTS WITH THE CONSTRUCTION DRAWINGS THEN STOP WORK AND CONTACT THE CLIENT AS SOON AS
- 10. IT IS THE CONTRACTORS RESPONSIBILITY TO VERIFY ALL DOT AND/OR COUNTY SPECIFICATIONS PRIOR TO BID AND CONSTRUCTION. IF THE SPECIFICATIONS DIFFER FROM THE CONSTRUCTION DRAWINGS, THEN THE SPECIFICATIONS WILL GOVERN. NO ADDITIONAL COSTS FOR ADHERING TO THE SPECIFICATIONS WILL BE ALLOWED AFTER THE BID HAS BEEN ISSUED AND ACCEPTED NOR WILL PROJECT DELAYS BE TOLERATED.
- 11. AT THE TIME THE CONSTRUCTION DRAWINGS WERE COMPLETED, KIMLEY-HORN AND ASSOCIATES DID NOT HAVE A COPY OF THE PROPOSED TOWER MANUFACTURER DRAWINGS THUS WE DO NOT KNOW THE EXACT SIZE OF THE OVERALL TOWER FOOTPRINT. THE CONTRACTOR MUST COMPARE THE CONSTRUCTION DRAWINGS WITH THE TOWER DRAWINGS PRIOR TO BID AND/OR CONSTRUCTION AND IF THEY FIND ANY DISCREPANCIES OR POSSIBLE ISSUES THEY MUST NOTIFY THE CLIENT IMMEDIATELY.



SBA NETWORK SERVICES, LLC. 8051 CONGRESS AVENUE BOCA RATON, FL 33487 TEL: (800) 487-7483


|Kimley » Horn

201 NORTH FRANKLIN STREET SUITE 1400 TAMPA, FL 33602 PHONE (813) 620-1460 WWW.KIMLEY-HORN.COM

THE INFORMATION CONTAINED IN THIS SET OF DOCUMENTS IS PROPRIETARY OTHER THAN THAT WHICH RELATES TO THE CLIENT IS STRICTLY PROHIBITED

A&E PROJECT #:	241149118
DRAWN BY:	JDS
CHECKED BY:	SM
REV. 1 BY:	VJS

	R	EVISIONS
-		
—	_	
Λ	11/26/24	ISSUED FOR CONSTRUCTION
		ISSUED FOR REVIEW
NO.	DATE	DESCRIPTION

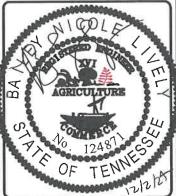

MT JULIET

TN29593-S

300 PLEASANT GROVE ROAD, SUITE 600 MOUNT JULIET, TN 37122

RAWLAND

400

OVERALL SITE PLAN

SHEET NUMBER

REVISION

FLOOD ZONE INFORMATION:

FLOOD ZONE:

PANEL NUMBER:


47189C0142E EFFECTIVE DATE: 05/09/2023

FLOOD ELEV. N/A

SITE PLAN

SCALE: 1" = 200

GRAPHIC SCALE

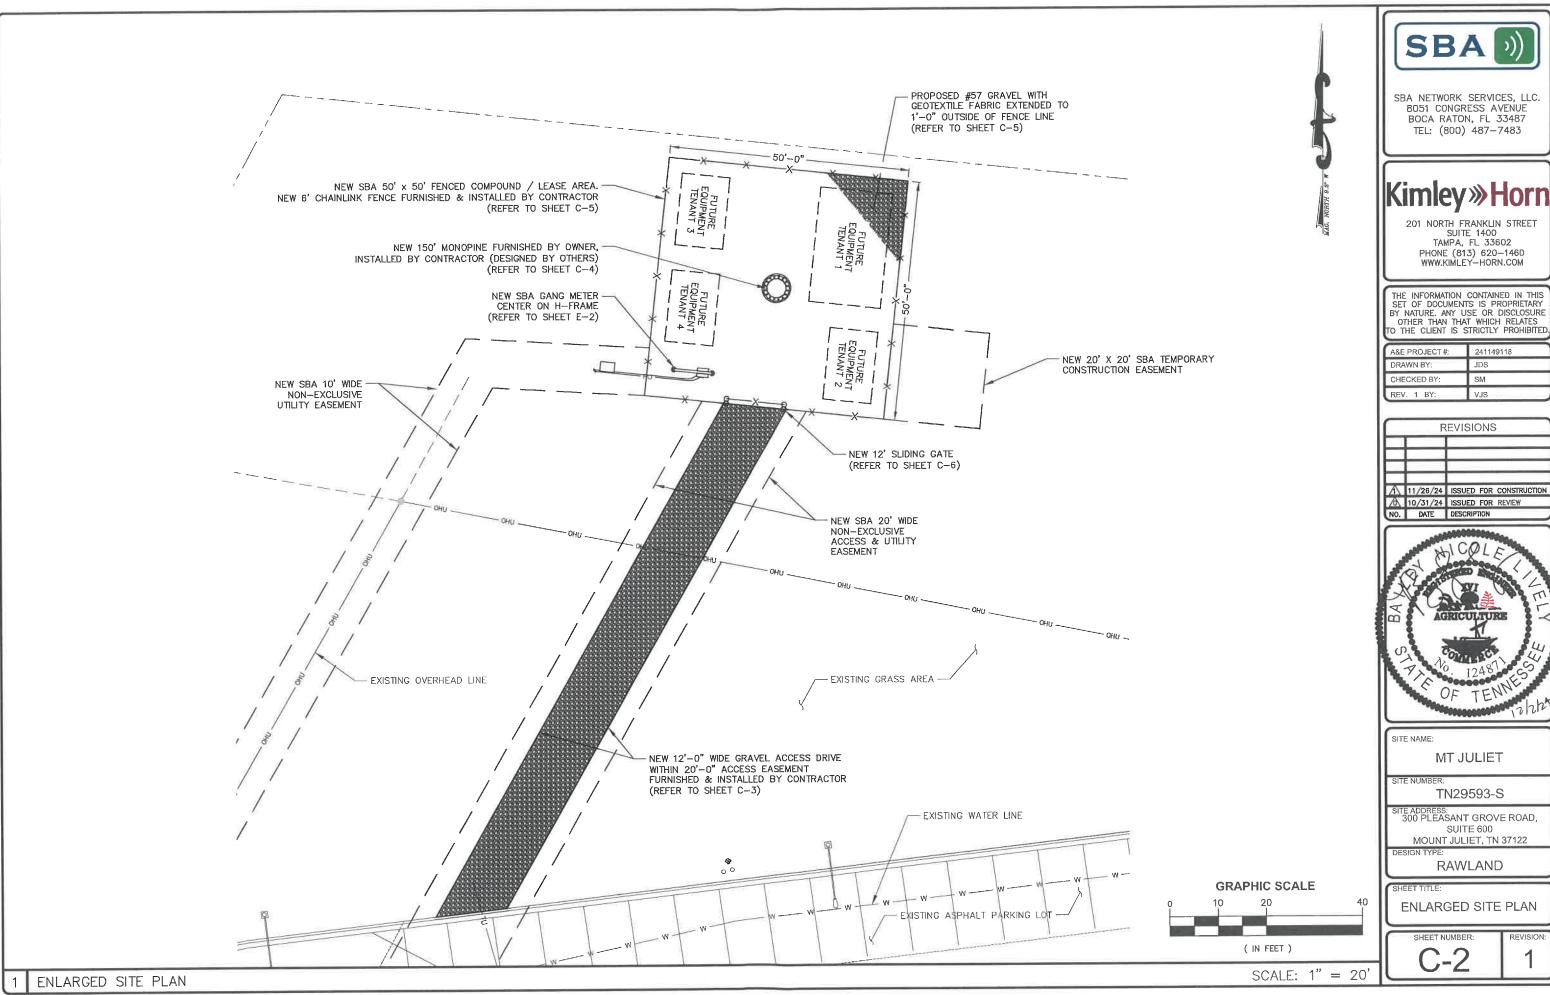




8051 CONGRESS AVENUE

Kimley » Horn

- 1	A&E PROJECT #:	241149118
- 1	DRAWN BY:	JDS
- 1	CHECKED BY:	SM
- 1	REV. 1 BY:	VJS

	REVISIONS	
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SBA

SBA NETWORK SERVICES, LLC. 8051 CONGRESS AVENUE BOCA RATON, FL 33487 TEL: (800) 487-7483

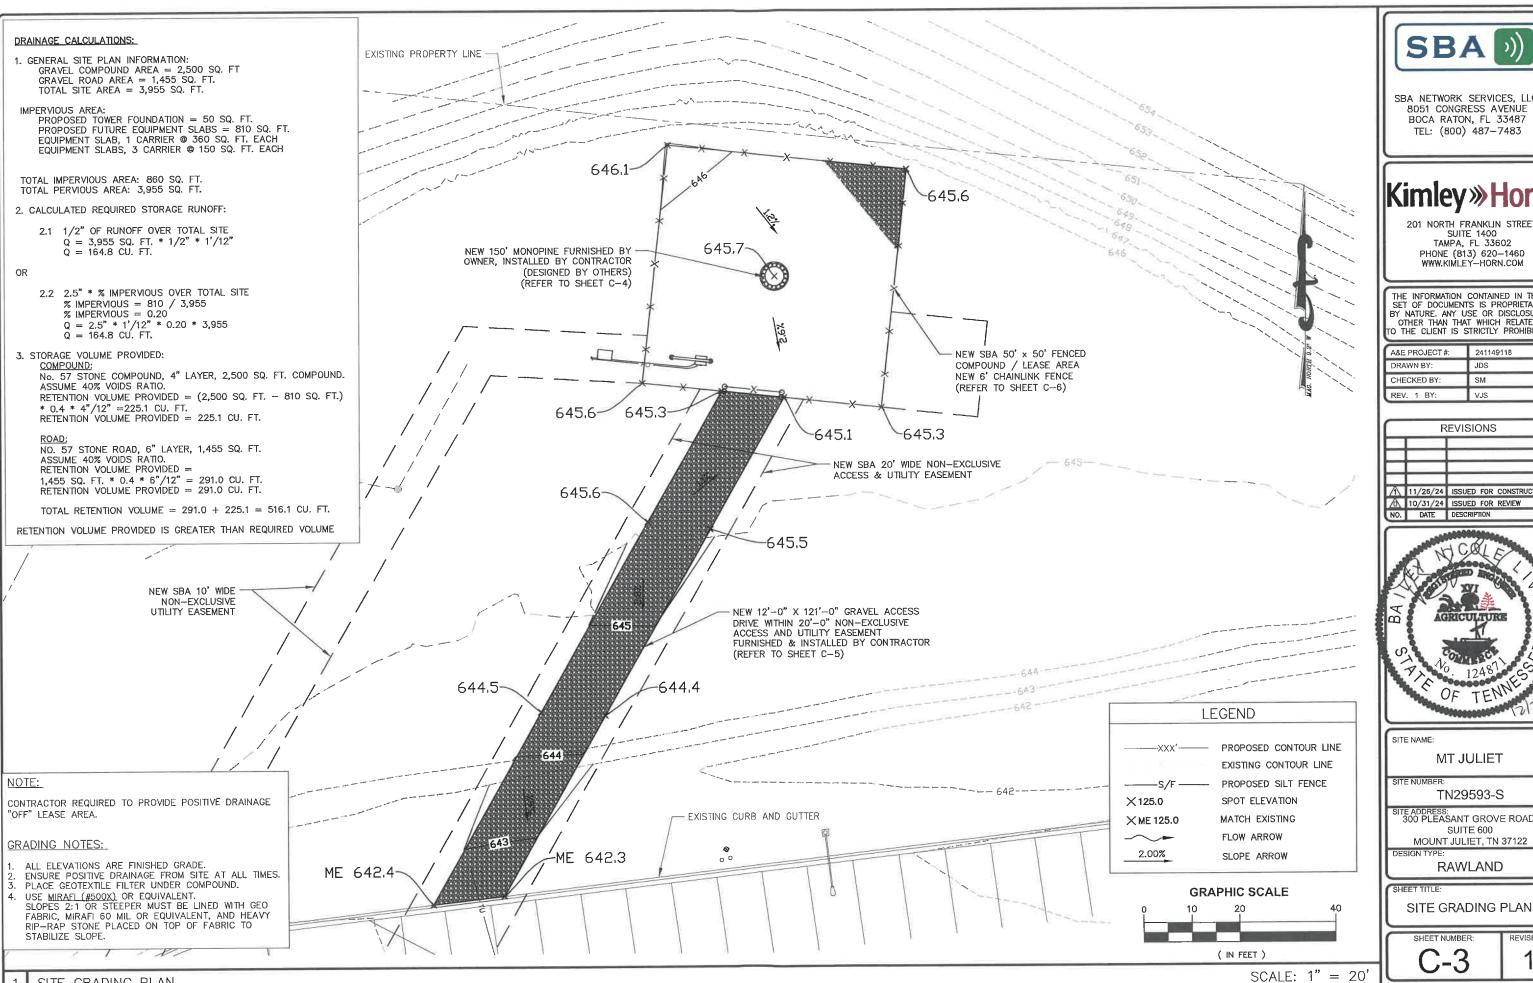Kimley » Horn

201 NORTH FRANKLIN STREET SUITE 1400 TAMPA, FL 33602 PHONE (813) 620-1460 WWW.KIMLEY-HORN.COM

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NO.	DATE	DESCRIPTION




MT JULIET

TN29593-S

ite address: 300 PLEASANT GROVE ROAD, SUITE 600


RAWLAND

SITE GRADING PLAN

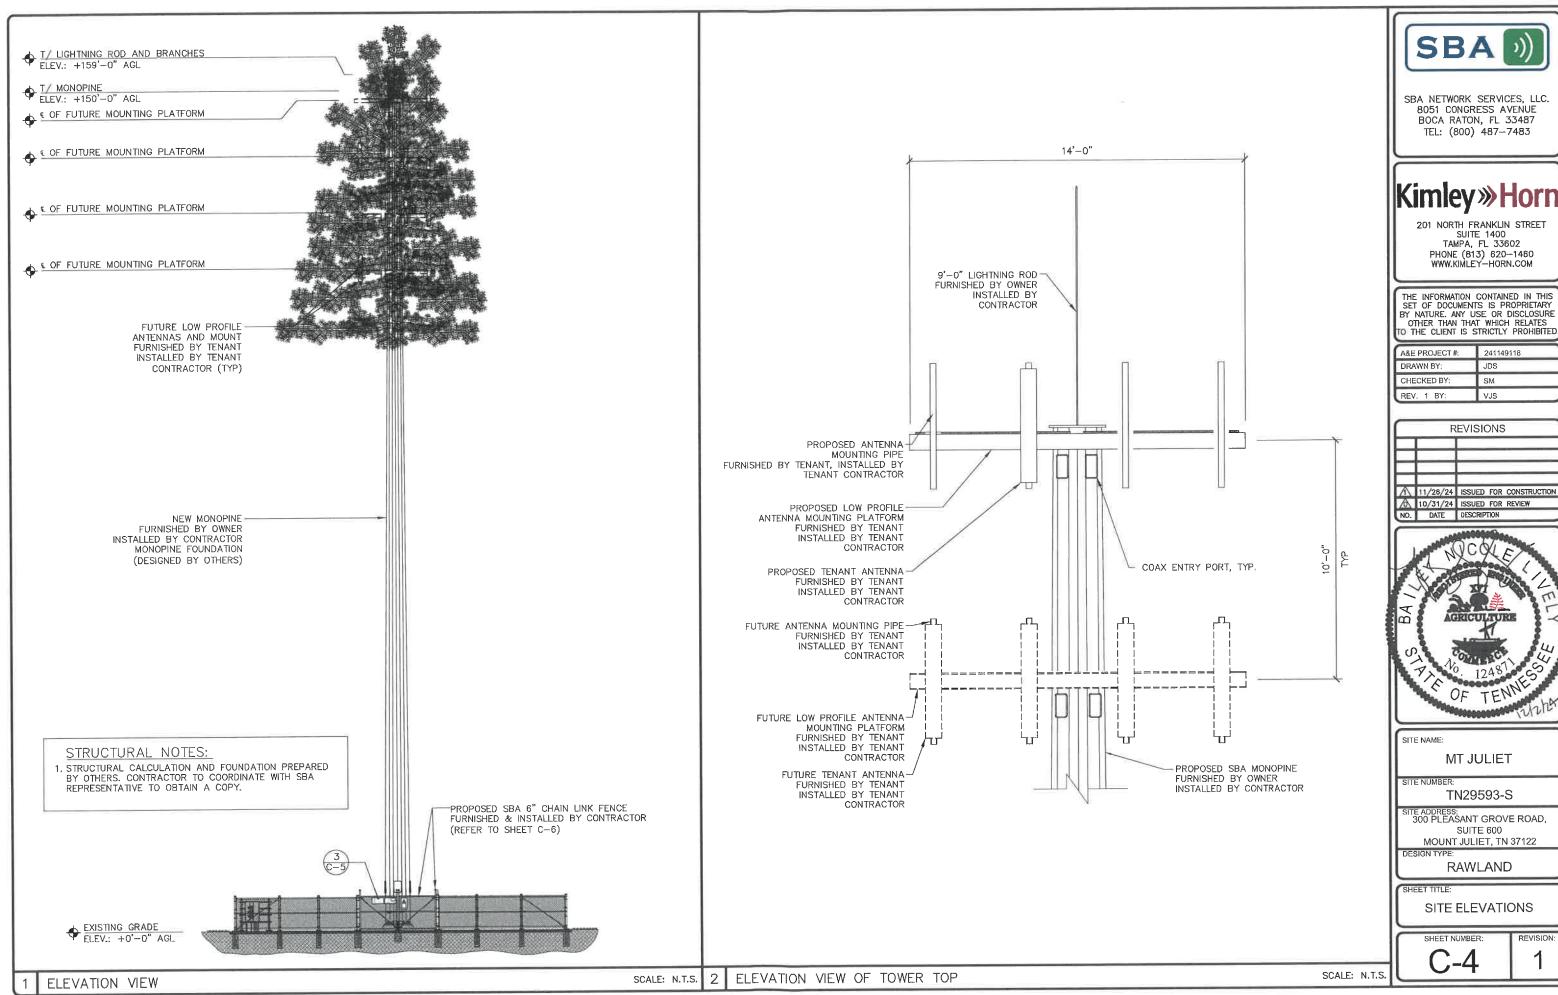

REVISIONS		
_		
_		
		ISSUED FOR CONSTRUCTION
10	10/31/24	ISSUED FOR REVIEW
NO.	DATE	DESCRIPTION



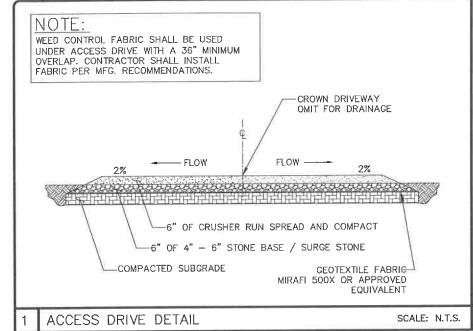

NOTE: WEED CONTROL FABRIC SHALL BE USED UNDER ENTIRE PROPOSED GRAVELED AREA WITH A 36" MINIMUM OVERLAP, CONTRACTOR SHALL INSTALL FABRIC PER MFG. RECOMMENDATIONS.

MAXIMUM DRY DENSITY (ASTM D-698)

NEW WEED CONTROL FABRIC, TENCATE MIRAFI WOVEN POLYPROPYLENE HP-370 GEOTEXTILE OR APPROVED EQUIVALENT

SUITABLE UNDISTURBED SUBGRADE. -REMOVE ALL ORGANIC OR UNSUITABLE MATERIAL AND COMPACT TO 90% OF THE STANDARD PROCTOR MAXIMUM DRY DENSITY (ASTM D-698)

COMPOUND FINISH DETAIL

NEW 4" THICK (MIN.) #57 WASHED STONE—SLOPE TO MAINTAIN POSITIVE DRAINAGE, COMPACT TO 90% OF THE STANDARD PROCTOR

NEW 3" THICK (MIN.) ABC (CRUSHER RUN) STONE-SLOPE T MAINTAIN POSITIVE DRAINAGE, COMPACT TO 90% OF THE STANDARD PROCTOR MAXIMUM DRY DENSITY (ASTM D-698)

SCALE: N.T.S.

NO SITE I.D.#: SBA D FCC#: LEASING (800)487-SITE (7483) ENTRY ONLY NETWORK SERVICES, INC. 1 - 8 0 0 - 8 2 5 - 7 0 2 9 WARNING CAUTION NOTICE
HAND PATS
REQUIRED IN THIS AUTHORISE PERCENTEL
ONL (DO NOT CLIMB ANTENNAS MAY BE TOWNERS WRITTEN
ACTIVE AUTHORIZATION 18"x24" .040 NEAREST HOSPITAL: ALUMINUM EMERGENCY #: 24"x18" SF C-X PLASTIC (TEMP)

FCC #: XXXXXXX SBA D 4"x18" .040 ALUMINUM. SBA TOWERS SITE I.D.#:

EMERGENCY (888) 950-SITE (7483) LEASING (809)487-SITE (7483)

18"x24" SF C-X

PLASTIC (TEMP)

SIGN DETAIL

18"x12" .040 NOTE: CONTRACTOR TO POST THE TEMPORARY SIGNS PRIOR TO

SITE CONSTRUCTION.

EMERGENCY (888) 950-SITE (7483) WWW.SBASITE.COM 12"x24"x.063 ALUMINUM CAUTION **PLEASE**

SBA

ALUMINUM

KEEP **GATE** CLOSED

18"x12" .040 ALUMINUM

SCALE: N.T.S

Kimley » Horr

SBA

SBA NETWORK SERVICES, LLC.

8051 CONGRESS AVENUE

BOCA RATON, FL 33487

TEL: (800) 487-7483

201 NORTH FRANKLIN STREET SUITE 1400 TAMPA, FL 33602 PHONE (813) 620-1460 WWW.KIMLEY-HORN.COM

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- 1	A&E PROJECT #:	241149118
- 1	DRAWN BY:	JDS
- 1	CHECKED BY:	SM
- 1	REV. 1 BY:	VJS

REVISIONS 11/26/24 ISSUED FOR CONSTRUCTION 10/31/24 ISSUED FOR REVIEW NO. DATE DESCRIPTION



SITE NAME

MT JULIET

SITE NUMBER TN29593-S

ITE ADDRESS: 300 PLEASANT GROVE ROAD, SUITE 600

MOUNT JULIET, TN 37122

RAWLAND

SITE DETAILS

SHEET NUMBER

CONTRACTOR SHALL INSPECT INSTALLED EROSION CONTROL DEVICE WEEKLY DURING CONSTRUCTION AND AFTER HEAVY RAINS FOR DAMAGE OR EXCESSIVE SILTATION, MAINTENANCE SHALL INCLUDE CLEANING BUILT-UP SEDIMENT BEHIND THE BARRIERS AND/OR REPLACING DAMAGED SECTIONS. THE EROSION CONTROL DEVICES SHALL BE MAINTAINED BY THE CONTRACTOR UNTIL PERMANENT STABILIZATION IS

4. HAY BALES SHALL NOT BE USED AS EROSION CONTROL.

CONTRACTOR SHALL BE RESPONSIBLE FOR CONSTRUCTION

AND MAINTENANCE OF EROSION AND SEDIMENTATION CONTROLS DURING CONSTRUCTION. INSTALL SILT FENCE AS SHOWN WHERE ADDITIONALLY REQUIRED FOR PROTECTION OF ADJACENT PROPERTIES, ROADWAYS, AND WATERWAYS.

NOTES:

CONTRACTOR IS RESPONSIBLE FOR PROVIDING SITE FREE OF DRAINAGE PROBLEMS.


CONTRACTOR SHALL USE BEST MANAGEMENT PRACTICES FOR CONSTRUCTION TO PREVENT THE DIVERSION OF SEDIMENT LADEN STORM WATER RUNOFF OR ERODED MATERIALS FROM LEAVING THE CONSTRUCTION SITE

- CONTRACTOR SHALL PREVENT TRACKING OF SEDIMENT OUTSIDE OF CONSTRUCTION LIMITS. THIS MAY REQUIRE CLEANING AND/OR WASHING OF DEBRIS AND SEDIMENT FROM ALL VEHICLES PRIOR TO EXITING THE SITE. ANY SEDIMENT DEPOSITED ON THE ROADWAY SHALL BE SWEPT AS NECESSARY THROUGHOUT THE DAY OR AT THE END OF EVERY DAY AND DISPOSED OF IN AN APPROPRIATE MANNER. SEDIMENT SHALL NOT BE WASHED INTO STORM SEWER SYSTEMS.
- ANY DEBRIS AND/OR SEDIMENT EXITING THE SITE DUE TO TRACKING OR FAILURE OF A SITE BMP SHALL BE CLEANED IMMEDIATELY BY THE CONTRACTOR BY A METHOD OTHER THAN FLUSHING. CONTRACTOR SHALL ALSO IMMEDIATELY REPAIR ANY BMPS THAT HAVE FAILED AND/OR INSTALL ADDITIONAL BMPS TO ENSURE SEDIMENT DOES NOT LEAVE



2

SET POSTS AND EXCAVATE A 4"X4" TRENCH UPSLOPE ALONG

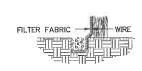

3. ATTACH THE FILTER FABRIC TO THE WIRE FENCE AND EXTEND IT INTO THE TRENCH.


2. STAPLE WIRE FENCING TO THE LINE OF POSTS.

SILT FENCE

EROSION CONTROL DETAIL

SCALE: N.T.S.

REVISION

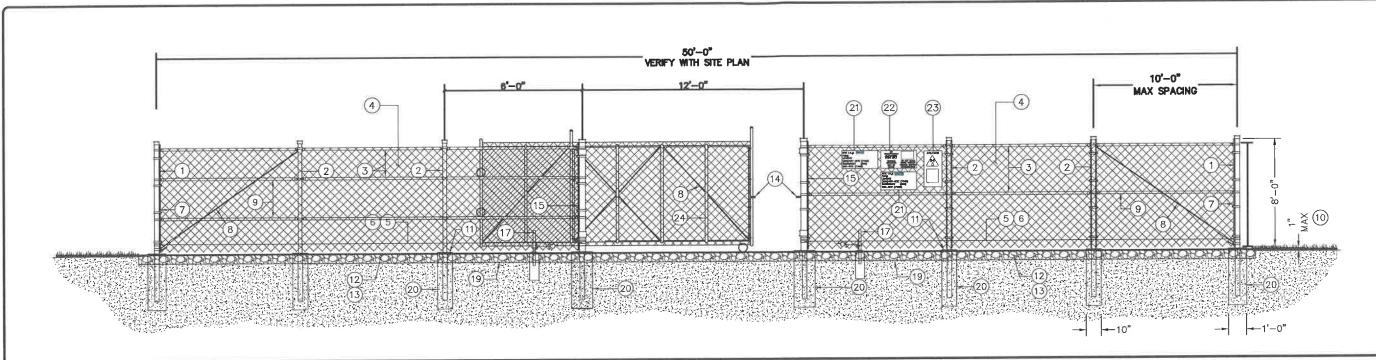

TYPICAL FENCING DETAIL

GENERAL NOTES:

- 1. INSTALL FENCING PER ASTM F-567
- 2. INSTALL SWING GATES PER ASTM F- 900
- 3. LOCAL ORDINANCE OF BARBED WIRE PERMIT REQUIREMENT SHALL BE COMPLIED IF REQUIRED.
- 4. POST & GATE PIPE SIZES ARE INDUSTRY STANDARDS. ALL PIPE TO BE GALVANIZED (HOT DIP, ASTM A120 GRADE "A" STEEL). ALL GATE FRAMES SHALL BE WELDED. ALL WELDING SHALL BE COATED WITH (3) COATS OF COLD GALV. (OR EQUIVALENT).
- 5. ALL OPEN POSTS SHALL HAVE END-CAPS.
- 6. USE GALVANIZED HOG-RING WIRE TO MOUNT ALL SIGNS.
- 7. ALL SIGNS MUST BE MOUNTED ON INSIDE OF FENCE FABRIC.
- 8. MUSHROOM ANCHOR & PLUNGER REQUIRED FOR GATE.
- 9. G.C. RESPONSIBLE FOR SBA COMBO GATE LOCK

BALLOON REFERENCE NOTES:

- (1) CORNER, END OR PULL POST: 3" O.D. SCHEDULE 40 PIPE.
- 2) LINE POST: 2 1/2" NOMINAL SCHEDULE 40 PIPE, PER ASTM-F1083. LINE POSTS SHALL BE EQUIVALENTLY SPACED AT MAXIMUM 10'-0" O.C.
- TOP RAIL & BRACE RAIL: 1-5/8"O.D. STANDARD ROUND PIPE, PER
- 4) FABRIC: 9 GA CORE WIRE SIZE 2" MESH, CONFORMING TO ASTM-A392
- TIE WIRE: 9 GA ALUMINUM. A SINGLE WRAP OF FABRIC TIE AND AT TENSION WIRE BY HOG RINGS SPACED 12" O.C. POSTS/GATES AND 24" RAILS/WIRE.
- (6) TENSION WIRE: 9 GA ALUMINUM
- (7) 3/16" x 3/4" (MIN) FULL HEIGHT STRETCHER BAR
- 3/8" DIAGONAL ROD WITH GALVANIZED STEEL TURNBUCKLE OR DIAGONAL THREADED ROD.
- (9) FENCE CORNER POST BRACE: 1 5/8" NOMINAL PIPE.
- (10) 1" MAXIMUM CLEARANCE FROM FINISH GRADE.
- (11) FENCE POST FOUNDATION TO BE 1" FINISH ABOVE FINISHED GRADE
- (12) 6" COMPACTED BASE MATERIAL
- (13) FINISH GRADE SHALL BE UNIFORM AND LEVEL.
- (14) LATCH & CATCH AS REQUIRED
- (15) GATE POST 4" O.D., SCHEDULE 40 PIPE, PER ASTM-F1083.
- (16) GATE FRAME BRACE RAIL: 1 1/2" NOMINAL PIPE, PER ASTM-F1083.
- 17) DUCK BILL OPEN GATE HOLDER. VERIFY LOCATION IN FIELD PRIOR TO INSTALLATION.
- (18) STYMIE LOCK MULTI-TENANT LOCKING DEVICE
- (19) GEOTEXTILE FABRIC
- 20 CONCRETE FOUNDATION (MIN 4000 PSI). MINIMUM DEPTH: 6" BELOW FROST LINE
- (21) 12" x 24" SBA SITE INFORMATION SIGN.
- (22) 12" x 24" NO TRESPASSING SIGN.
- (23) 12" x 24" RF CAUTION SIGN.
- (24) 2" SCH. 40 PIPE AT EACH END & 1/3 POINTS IN OVERALL FRAME

SBA

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	A&E PROJECT#:	241149118
	DRAWN BY:	JDS
SCALE: N.T.S.	CHECKED BY:	SM
	REV. 1 BY:	VJS

STRUCTION
EW



MT JULIET

TN29593-S

TE ADDRESS: 300 PLEASANT GROVE ROAD, SUITE 600

MOUNT JULIET, TN 37122

RAWLAND

FENCE DETAILS

SCALE: N.T.S. 4 NOT USED

GENERAL NOTES

SCALE: N.T.S.

FENCING NOTES

SCALE: N.T.S

LINES SHOWN DO NOT REPRESENT THE EXACT LOCATION OF THE CONDUIT RUNS. CONTRACTOR TO VERIFY SERVICE LOCATIONS w/ACTUAL FIELD CONDITIONS. REFER TO UTILITY COORDINATION DOCUMENT FOR CONDUIT RUNS AND ASSOCIATED PARAMETERS (BY OTHERS). NEW SBA 50' x 50' FENCED COMPOUND / LEASE AREA NEW 150' MONOPINE NEW POWER HANDHOLE -(BY OTHERS) NEW U/G POWER FROM NEW POWER HANDHOLE TO NEW METER CENTER. (2) 4" SCH 40 PVC. EXTEND OUTSIDE COMPOUND 5' MINIMUM. COORDINATE W/ UTILITY COMPANY FOR ROUTING. NEW SBA UTILITY CENTER PROVIDED BY AND INSTALLED BY CONTRACTOR NEW SBA 10' WIDE (REFER TO SHEET E-2) NON-EXCLUSIVE UTILITY EASEMENT PROPOSED U/G FIBER ROUTED TO RIGHT-OF-WAY (BY OTHERS) **GRAPHIC SCALE**

UTILITY SITE PLAN

GENERAL ELECTRICAL NOTES

- 1.) ALL ELECTRICAL WORK SHALL CONFORM TO NATIONAL ELECTRIC CODE, LATEST ADOPTED EDITION, AND LOCAL CODES.
- 2.) ALL ELECTRICAL MATERIALS, EQUIPMENT AND INSTALLATION PROCEDURES TO CONFORM WITH SBA SPECIFICATIONS.
- 3.) CONTRACTOR SHALL PERFORM ALL VERIFICATION TESTS AND EXAMINATION WORK PRIOR TO THE ORDERING OF THE ELECTRICAL EQUIPMENT AND THE ACTUAL CONSTRUCTION. CONTRACTOR SHALL ISSUE A WRITTEN NOTICE OF ALL FINDINGS TO THE ENGINEER LISTING ALL MALFUNCTIONS, FAULTY EQUIPMENT & DISCREPANCIES.
- 4.) ELECTRICAL PLANS, DETAILS, AND DIAGRAMS ARE DIAGRAMMATIC ONLY. FIELD CONDITIONS DICTATE THE AMOUNT AND LOCATION OF EQUIPMENT.
- 5.) ALL MATERIALS SHALL BE MANUFACTURED IN ACCORDANCE WITH APPLICABLE STANDARDS ESTABLISHED BY ANSI, NEMA, NFPA, AND "UL" LISTED.
- 6.) THE ENTIRE ELECTRICAL INSTALLATION SHALL BE GROUNDED AS REQUIRED BY THE NEC, AND ALL APPLICABLE LOCAL CODES.
- 7.) ALL CIRCUIT BREAKERS, FUSES AND ELECTRICAL EQUIPMENT SHALL HAVE A MINIMUM INTERRUPTING RATING GREATER THAN THE UTILITY FAULT CURRENT.
- 8.) FOR COMPLETE INTERNAL WIRING AND ARRANGEMENT REFER TO VENDOR PRINTS AND INSTRUCTIONS.
- 9.) PATCH, REPAIR AND PAINT ANY AREA THAT HAS BEEN DAMAGED IN THE COURSE OF THE ELECTRICAL WORK.
- 10.) PROVIDE SBA WITH ONE SET OF COMPLETE ELECTRICAL "AS-BUILT" DRAWINGS AT THE COMPLETION OF THE JOB SHOWING ACTUAL ROUTINGS AND WIRING CONNECTIONS.
- 11.) LABEL ALL ELECTRICAL EQUIPMENT PER SBA SPECIFICATIONS.
- 12.) ALL SINGLE-PHASE SELF-CONTAINED METER CONNECTION DEVICES MUST INCLUDE HORN TYPE BY-PASS PROVISION SO THAT SERVICE WILL NOT BE INTERRUPTED WHEN A METER IS REMOVED FROM THE SOCKET.
- 13.) ALL EQUIPMENT PUNCH OUTS AND CONDUITS (USED AND SPARE) TO BE "RODENT PROOFED" WITH CAPS, STEEL MESH, AND/OR FOAM FILL BY CONTRACTOR (AS NEEDED).
- 14.) ALL INTERIOR CONDUITS AND BUSHINGS SHALL BE EMT. ALL EXTERIOR SHALL BE PVC UNLESS NOTED OTHERWISE. SEE SBA SPECIFICATIONS.
- 15.) NO SPOILS TO BE LEFT ON SITE WITHOUT THE WRITTEN CONSENT OF THE LANDOWNER
- 16.) CONTRACTOR TO PROVIDE 2 PHENOLIC LABELS AT METER. ONE TO IDENTIFY "SBA DISCONNECT" AND THE OTHER TO GIVE SITE ADDRESS.

CODES AND STANDARDS

ANSI AMERICAN NATIONAL STANDARDS INSTITUTE
NEC NATIONAL ELECTRICAL CODE, LATEST ADOPTED EDITION
NEMA NATIONAL ELECTRICAL MANUFACTURER'S ASSOCIATION
NFPANATIONAL FIRE PROTECTION ASSOCIATION
UL UNDERWRITERS LABORATORIES, INC.

(IN FEET)

SCALE" 1" = 10'



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CHECKED BY:	SM
REV. 1 BY:	VJS

	R	EVISIONS	3
1	11/26/24	ISSUED FOR	CONSTRUCTION
10	10/31/24	ISSUED FOR	REVIEW
NO.	DATE	DESCRIPTION	
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SITE NAME

MT JULIET

TN29593-S

TE ADDRESS: 300 PLEASANT GROVE ROAD, SUITE 600


MOUNT JULIET, TN 37122 IGN TYPE: RAWLAND

UTILITY SITE PLAN

SHEET NUMBER

E-1

REVISION

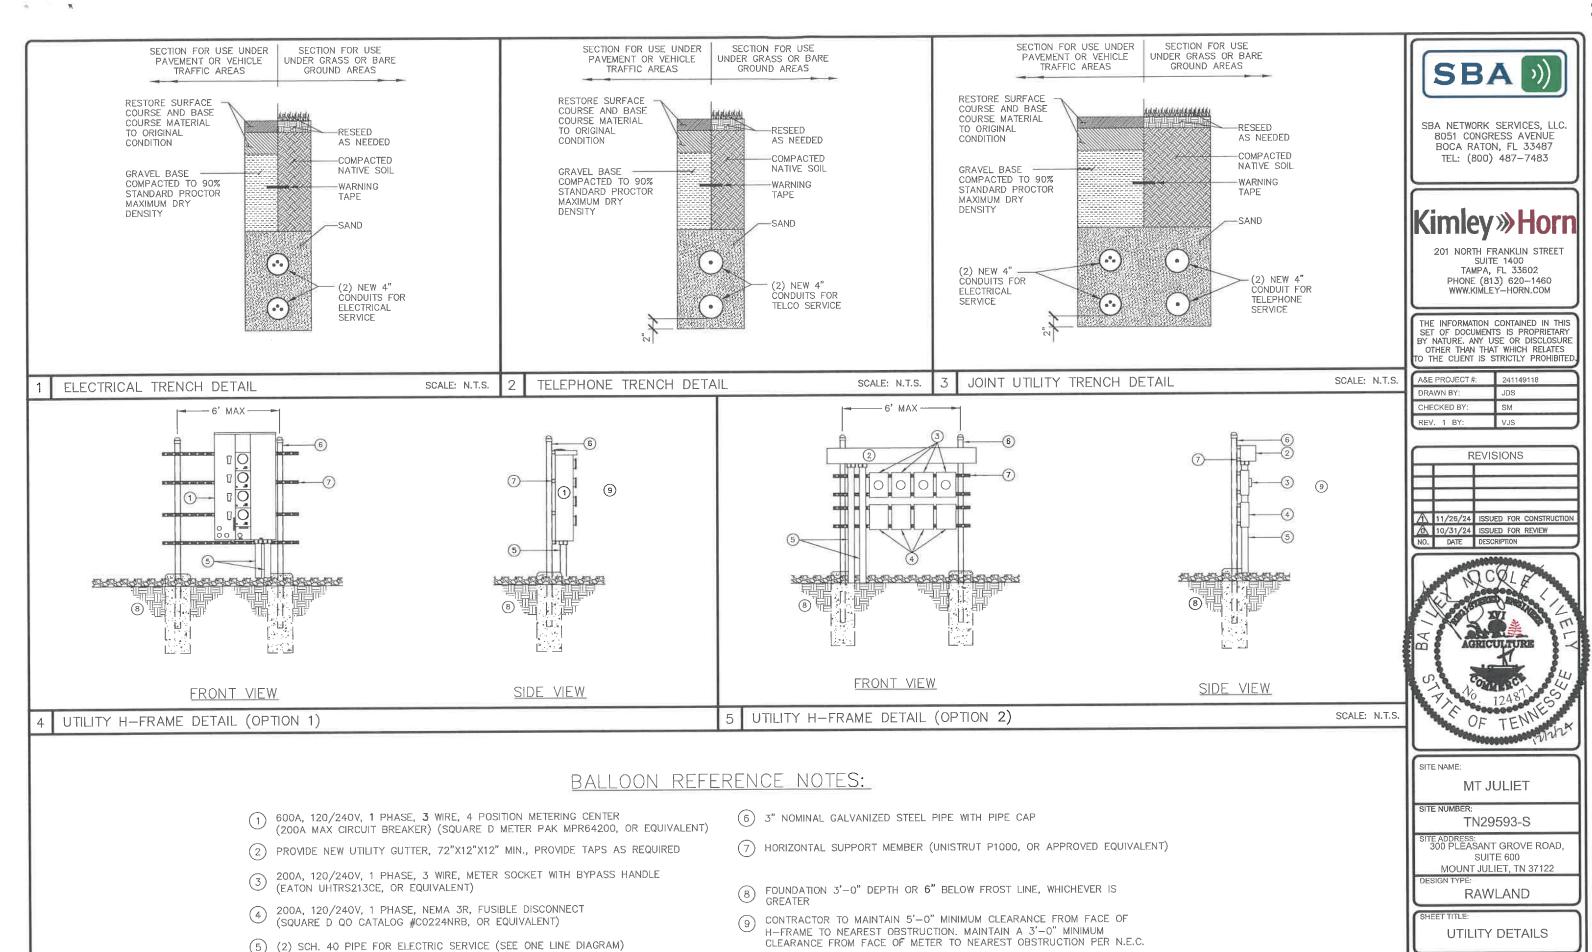

SCALE: N.T.S.

F_2

IF: NTS

2 | 1

		ELI	ECTRICAL	
CIRCUIT ID	VOLTS	MAX ONE WAY LENGTH OF RUN	CIRCUIT SIZE (2H+N)	CONDUIT Ø
[A] 120/		300FT	2 PARALLEL SETS (3) 350 MCM	(2) 3-1/2"
	120/240V	350FT	2 PARALLEL SETS (3) 400 MCM	(2) 3-1/2"
		450FT	2 PARALLEL SETS (3) 500 MCM	(2) 4"
		500FT	2 PARALLEL SETS (3) 600 MCM	(2) 4"
		600FT	2 PARALLEL SETS (3) 700 MCM	(2) 4"
		650FT	2 PARALLEL SETS (3) 750 MCM	(2) 4"

CIRCUITS SIZED FOR LESS THAN 3.0% OF VOLTAGE DROP
 PARALLEL SETS OF WIRES, EACH SET IN SEPARATE CONDUIT
 ALL CIRCUITS SHALL BE CU, AWG, THWN



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MT JULIET

TN29593-S

SITE ADDRESS: 300 PLEASANT GROVE ROAD,


SUITE 600 MOUNT JULIET, TN 37122


RAWLAND

ELECTRICAL DETAILS

SHEET NUMBER

REVISION:

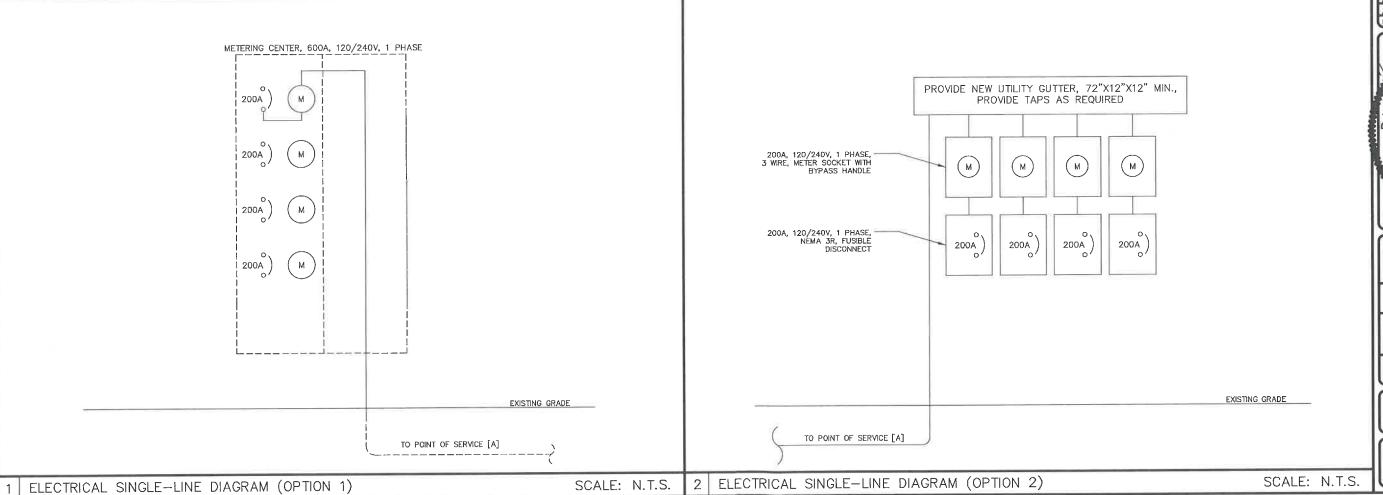

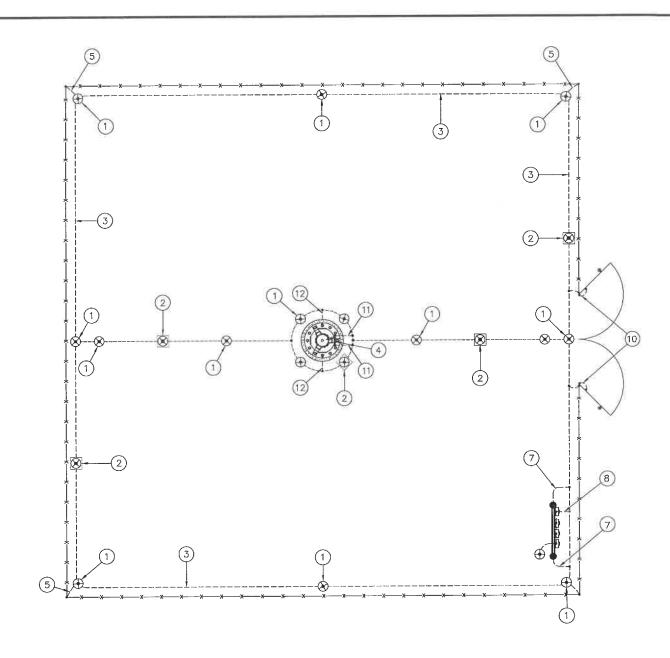

BALLOON REFERENCE NOTES:

#2 SOLID, TINNED, BARE COPPER GROUND LEAD FROM GROUND BAR AT MONOPOLE BASE TO GROUND RING. ROUTE IN 3/4" FLEX CONDUIT AND WEATHERPROOF OPEN END. (2 TYPICAL)

#2 SOLID, TINNED, BARE COPPER GROUND LEAD FROM MONOPOLE

BASE TO GROUND RING. (2 TYPICAL, 180" SEPARATION)

- (1) 5/8"~X8' COPPER CLAD GROUND ROD BURIED 36" BELOW GRADE (MIN.) #2 INSULATED, STRANDED COPPER BOND STRAP FROM GATE FRAME TO GATE POST. (TYP EACH GATE)
- 2) GROUND ROD ACCESS WELL (MIN. OF 4 EACH PER COMPOUND)
- #2 SOLID, TINNED, BARE COPPER WIRE GROUND RING (CONTINUOUS STRAND)
- 1/4"X4"X20" TINNED COPPER GROUND BAR. 2 TYP, AT BASE AND TOP OF TOWER. MOUNT DIRECT TO TOWER, DO NOT ISOLATE.
- (5) #2 SOLID, TINNED, BARE COPPER WIRE GROUND LEAD TO FENCE CORNER POST.
- 7) #2 SOLID, TINNED, BARE COPPER WIRE GROUND LEAD TO UTILITY H-FRAME SUPPORT POST
- (8) SERVICE ENTRANCE GROUND TO DEDICATED GROUND ROD
- 9 N/A

SYMBOLS LEGEND

GROUND ROD WITH ACCESS MECHANICAL CONNECTION

 \bigcirc

ENLARGED GROUNDING PLAN @ TOWER BASE (TYP)

GROUND ROD

EXOTHERMIC CONNECTION

GROUND BAR GROUND WIRE

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N.T.S.

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SBA


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MT JULIET

TN29593-S

re address: 300 PLEASANT GROVE ROAD, SUITE 600

MOUNT JULIET, TN 37122

RAWLAND

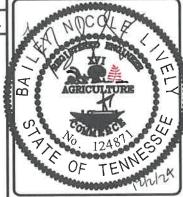GROUNDING PLAN


& DETAILS

EG-

3 ENLARGED GROUNDING PLAN @ UTILITY H-FRAME

SITE GROUNDING PLAN (TYP.)

N.T.S.

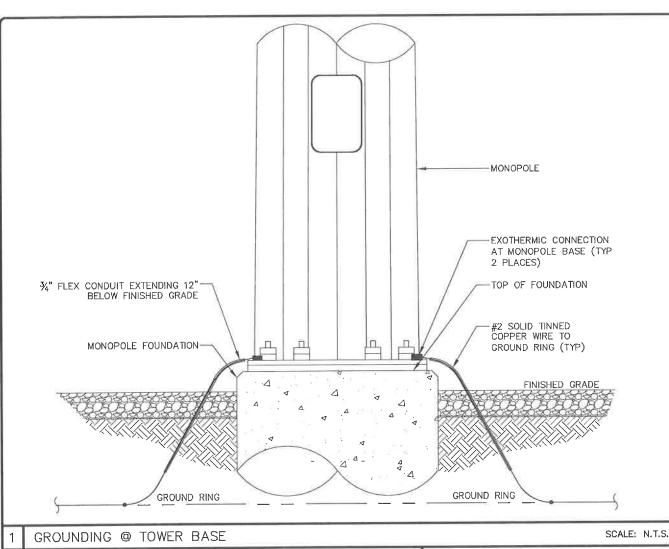

CADWELD CONNECTIONS (OR APPROVED EQUIVALENT)



PARALLEL HORIZONTAL CONDUCTORS PARALLEL THROUGH CONNECTION OF HORIZONTAL CABLES TYPE PT



THROUGH CABLE TO GROUND ROD THROUGH CABLE TO TOP OF GROUND ROD TYPE



HORIZONTAL SPLICE SPLICE OF HORIZONTAL CABLES



HORIZONTAL STEEL SURFACE TO FLAT STEEL SURFACE OR HORIZONTAL PIPE TYPE



VERTICAL STEEL SURFACE CABLE DOWN AT 45° TO VERTICAL STEEL SURFACE INCLUDING PIPE TYPE VS



VERTICAL PIPE CABLE DOWN AT 45° TO RANGE OF VERTICAL PIPES TYPE VS

SINGLE-LINE DIAGRAM

BURNDY CONNECTIONS (OR APPROVED EQUIVALENT)



"C" CONNECTOR HYPRESS TYPE YGHC



BOND JUMPER FIELD FABRICATED GREEN STRANDED INSULATED TYPE 2-YA-2



COPPER LUGS TWO HOLE - LONG BARREL LENGTH TYPE YA-2

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MT JULIET

TN29593-S

300 PLEASANT GROVE ROAD, SUITE 600

MOUNT JULIET, TN 37122 **RAWLAND**

GROUNDING DETAILS

SCALE: N.T.S

EG-2


TYPICAL WELDING CONNECTIONS SCALE: N.T.S.


GROUNDING ROD DETAIL

SCALE: N.T.S.

PENTEK OR EQUIVALENT 6"ø ECONO TURF BOX WITH LOCKING DROP-IN LID. INSERT 6"¢ X 36" SCH 40 PVC TEST WELL PIPE INTO TURF BOX AND SECURE WITH PVC GLUE. USE PENTEK PART #182101. FINISHED GRADE #2 BTW TEST WIRE WHERE APPLICABLE EXOTHERMIC CONNECTION #2 SOLID TINNED BARE COPPER GROUND RING CONDUCTOR 8" MIN. CRUSHED STONE

ACCESS WELL DETAIL

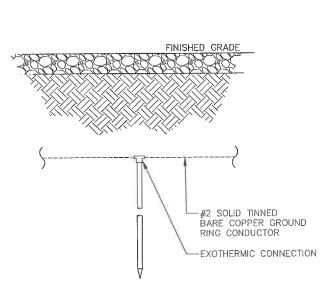

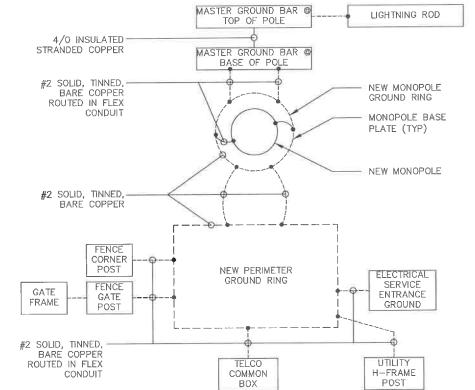



SCALE: N.T.S.



Mt. Juliet, Tennessee Staff Report

2425 North Mt. Juliet Rd Mt. Juliet, TN 37122

File #: 0989 **Agenda Date:** 1/9/2025 **Agenda #:** 3.B.

Title:

Review the Zoning Variance Application for the New Telecommunications Tower, located at 300 Pleasant Grove Rd.

PROJECT SUMMARY

SITE NAME:

MT JULIET

SITE ADDRESS:

300 PLEASANT GROVE ROAD,

MOUNT JULIET, TN 37122

JURISDICTION:

CITY OF MOUNT JULIET

COUNTY:

WILSON COUNTY

ZONING:

CMII-PLID COMMERCIAL MIXED USE DISTRICT

PLANNED UNIT DEVELOPMENT

PROPERTY OWNER:

WAL-MART REAL ESTATE

BUSINESS TRUST

ADDRESS:

P.O. BOX 8050 BENTONVILLE, AR 72716

APPLICANT:

SBA TOWERS IX LLC, 8051 CONGRESS AVENUE BOCA RATON, FL 33487 OFFICE: (800) 487-7483

FAX: (561) 226-3572

SBA CONTACT:

SITE COORDINATES:

LATITUDE: LONGITUDE:

ELEVATION:

36° 10′ 48.94″ N 86° 31′ 11.96″ W

645.32

(NAD 83/2011) (NAD 83/2011)

(NAVD 88)

JOSE MANCILLA / (561) 981-7381

072.12-000 PARCEL NUMBER:

HANDICAPPED REQUIREMENTS

FACILITY IS UNMANNED AND NOT FOR HUMAN HABITATION. HANDICAP ACCESS NOT REQUIRED.

PLUMBING REQUIREMENTS

FACILITY HAS NO PLUMBING.

CONSULTING TEAM

ARCHITECTURAL - ENGINEERING FIRM: KIMLEY-HORN 655 NORTH FRANKLIN STREET SUITE 150 TAMPA, FL 33602

CONTACT: TONY DAWSON PHONE: (813) 620-1460

PHONE: (386) 418-0500

SURVEYING FIRM: GEOLINE SURVEYING, INC. 13430 NW 104TH TERRACE, SUITE A ALACHUA, FL 32615 CONTACT: ZACK WALL

UTILITIES INFORMATION

POWER COMPANY:

FIBER COMPANY:

CONTACT: TBD PHONE: TBD

CONTACT: TBD PHONE: TBD



SITE NAME JULIET

SITE I.D. TN29593-S

E911 ADDRESS

300 PLEASANT GROVE ROAD, SUITE 600 MOUNT JULIET, TN 37122


PROJECT TYPE

MONOPINE CONSTRUCTION DRAWINGS

VICINITY MAP

- SITE LOCATION NOT TO SCALE

REGIONAL MAP

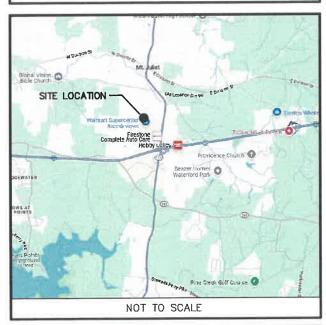

DRIVING DIRECTIONS

FROM NASHVILLE INTERNATIONAL AIRPORT:

DIRECTIONS: HEAD ONTO TERMINAL DRIVE AND MERGE ONTO I-40 E TOWARD KNOXVILLE. DRIVE FOR ABOUT 10 MILES ON I-40 E, THEN TAKE EXIT 226A FOR MT. JULIET ROAD NORTH (TN-171). MERGE ONTO MT. JULIET ROAD AND CONTINUE FOR ABOUT 1.5 MILES. NEXT, TURN RIGHT ONTO PLEASANT GROVE ROAD, AND THE SITE WILL BE ON THE LEFT AFTER APPROXIMATELY 0.3 MILES AT 300 PLEASANT GROVE ROAD.

SHEET SCALE FACTOR:

PLOT SIZE: 11"x17": "TO SCALE" 24"x36": 2X SCALE AS NOTED



CHEET INDEX

	SHEET INDEX			
NO.	DESCRIPTION			
T-1	TITLE SHEET			
T-2	ABBREVIATIONS & SYMBOLS LEGEND			
GN-1	GENERAL NOTES			
GN-2	GENERAL NOTES			
LS-1	LAND SURVEY			
LS-2	LAND SURVEY			
LS-3	LAND SURVEY			
LS-4	LAND SURVEY / LEGAL DESCRIPTION			
C-1	OVERALL SITE PLAN			
C-2	ENLARGED SITE PLAN			
C-3	SITE GRADING PLAN			
C-4	SITE ELEVATIONS			
C-5	SITE DETAILS			
C-6	FENCE DETAILS			
E-1	UTILITY SITE PLAN			
E-2	UTILITY DETAILS			
E-3	SINGLELINE DIAGRAM			
EG-1	GROUNDING PLAN & DETAILS			
EG-2	GROUNDING DETAILS			

Α	DATE	
TITLE	SIGNATURE	
SBA CONST. MGR:		
PROPERTY OWNER:		
PLANNING:		


THE ABOVE SHOWN PARTIES HEREBY APPROVE AND ACCEPT THESE DOCUMENTS AND AUTHORIZE THE CONTRACTOR TO PROCEED WITH THE CONSTRUCTION DESCRIBED HEREIN. ALL DOCUMENTS ARE SUBJECT TO REVIEW BY THE LOCAL BUILDING DEPARTMENT AND MAY IMPOSE CHANGES OR MODIFICATIONS.

ALL WORK SHALL BE PERFORMED AND MATERIALS INSTALLED IN ACCORDANCE WITH THE CURRENT EDITIONS OF THE FOLLOWING CODES AS ADOPTED BY THE OCAL GOVERNING AUTHORITIES. NOTHING IN THESE PLANS IS TO BE CONSTRUED TO PERMIT WORK NOT CONFORMING TO THESE CODES.

TBC 2012, LATEST EDITION TBC 2012, LATEST EDITION TPC 2012, LATEST EDITION BUILDING/DWELLING CODE: STRUCTURAL CODE: PLUMBING CODE: ECHANICAL CODE: TMC 2012, LATEST EDITION TEC 2017, LATEST EDITION FLECTRIC CODE: TLSC 2012, LATEST EDITION TRE CODE: TFC 2012, LATEST EDITION DESIGN WIND SPEED: RISK CATEGORY: EXPOSURE CATEGORY:

STATE COUNTY MAP

TENNESSEE

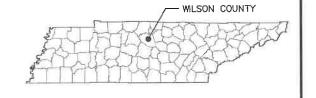

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JDS
SM
VJS

\subseteq	R	EVISIONS	3
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SITE NAME:

MT JULIET

TN29593-S

TE ADDRESS: 300 PLEASANT GROVE ROAD, SUITE 600 MOUNT JULIET, TN 37122

RAWLAND

TITLE SHEET

SHEET NUMBER

ABBREVIATIONS

AB	ANCHOR BOLT	GR	GRADE
AC	ASPHALTIC CONCRETE	GYP	GYPSUM
A/C	AIR CONDITIONING	GFCI	GROUND FAULT CIRCUIT
ADJ	ADJUSTABLE		INTERRUPT
A.F.F.	ABOVE FINISH FLOOR	GND	GROUND
ARCH	ARCHITECTURAL	HC	HOLLOW CORE
APPROX	APPROXIMATELY	HDW	HARDWARE
A.G.L.	ABOVE GRADE LEVEL	HTR	HEATER
		НМ	HOLLOW METAL
A.M.S.L.	ABOVE MEAN SEA LEVEL	HORIZ	HORIZONTAL
BD	BOARD		HOUR
BLDG	BUILDING	HR	HEIGHT
BLKG	BLOCKING	HT	
BOT	воттом	HV	HIGH VOLTAGE
BSMT	BASEMENT	ID	INSIDE DIMENSION
BTS	BASE TRANSCEIVER	INS	INSULATION
	STATION	INT	INTERIOR
С	COURSE(S)	JT	JOINT
CEM	CEMENT	LAM	LAMINATED
CL	CHAIN LINK	LBS	POUNDS
CLG	CEILING	LT	LIGHT
CLR	CLEAR	LA	LIGHTNING ARRESTOR
COL	COLUMN	LNA	LOW NOISE AMPLIFIER
CONC	CONCRETE	MFR	MANUFACTURER
CONST	CONSTRUCTION	MAT	MATERIAL
CONT	CONTINUOUS	MAX	MAXIMUM
CORR	CORRIDOR	MECH	MECHANICAL
CO	CONDUIT ONLY	MIN	MINIMUM
DIA	DIAMETER	MISC	MISCELLANEOUS
		ML	METAL LATH
DBL	DOUBLE DEPARTMENT	MO	MASONRY OPENING
DEMO	DEMOLITION	MS	MACHINE SCREW
DIM	DIMENSION	MTD	MOUNTED
	DOWN	MTL.	METAL
DN		(N)	NEW
DR	DOOR	NIC	NOT IN CONTRACT
DTL	DETAIL	NO	NUMBER
DWG	DRAWNG	NTS	NOT TO SCALE
(E)	EXISTING		
EA	EACH	0	OVERHEAD
ELEC	ELECTRIC	OA O.C.	OVERALL
ELEV	ELEVATION	0.C.	ON CENTER
EQUIP	EQUIPMENT	OPNG	OPENING
EXP	EXPANSION	OPP	OPPOSITE
EXT	EXTERIOR	PARTN	PARTITION
FA	FIRE ALARM	PL	PLATE
FB	FLAT BAR	PLAS	PLASTER
FF	FINISH FLOOR	PLYWD	PLYW00D
FH	FLAT HEAD	POC	POINT OF CONNECTION
FIN	FINISH(ED)	PROP	PROPERTY
FLR	FLOOR	PT	PRESSURE TREATED
		R	RISER
FOS	FACE OF STUDS		
FOS FS	FACE OF STUDS	REOD	REQUIRED
FS	FINISH SURFACE	REQD RD	REQUIRED ROOF DRAIN
FS FT	FINISH SURFACE FOOT, FEET	RD	ROOF DRAIN
FS FT FTG	FINISH SURFACE FOOT, FEET FOOTING	RD RM	ROOF DRAIN ROOM
FS FT FTG FW	FINISH SURFACE FOOT, FEET FOOTING FINISH WALL	RD RM RMS	ROOF DRAIN ROOM ROOMS
FS FT FTG FW F.G.	FINISH SURFACE FOOT, FEET FOOTING FINISH WALL FINISH GRADE	RD RM RMS RO	ROOF DRAIN ROOM ROOMS ROUGH OPENING
FS FT FTG FW	FINISH SURFACE FOOT, FEET FOOTING FINISH WALL	RD RM RMS RO SC	ROOF DRAIN ROOMS ROUGH OPENING SOLID CORE
FS FT FTG FW F.G.	FINISH SURFACE FOOT, FEET FOOTING FINISH WALL FINISH GRADE	RD RM RMS RO SC SCHED	ROOF DRAIN ROOM ROOMS ROUGH OPENING SOLID CORE SCHEDULE
FS FT FTG FW F.G. FUT	FINISH SURFACE FOOT, FEET FOOTING FINISH WALL FINISH GRADE FUTURE	RD RM RMS RO SC	ROOF DRAIN ROOMS ROUGH OPENING SOLID CORE

SHEET

SHT


SIMILAR
SPECIFICATIONS
STAINLESS STEEL
STEEL
STORAGE
STRUCTURAL
SUSPENDED
SWITCH
SWITCHBOARD
THICK
TENANT IMPROVEMENT
TOWER MOUNTED AMPLIFIER
TOP OF SURFACE
TUBE STEEL
TYPICAL
UNDERGROUND
UNLESS NOTED
OTHERWISE
VINYL
COMPOSITION
TILE
VERTICAL
VERIFY IN FIELD
VERTICAL GRAIN
WITH
WOOD
WATER RESISTANT
WEIGHT
TRANSFORMER
AT
CHANNEL
CENTERLINE




ANGLE

PROPERTY LINE


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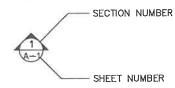
BUILDING SECTION REFERENCE

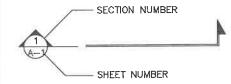


DETAIL REFERENCE

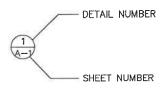

DETAIL SECTION REFERENCE

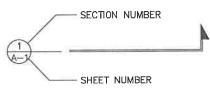

ELEVATION VIEW REFERENCE

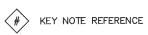


101) DOOR NUMBER

101 AREA AND/OR ROOM NUMBER



A MECHANICAL UNIT

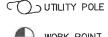

WORK POINT



#\ REVISION OR CONTROL POINT



ELEVATION REFERENCE

SYMBOLS:

	MASONRY
	BRICK
	CONCRETE
	EARTH
	STEEL
500000000000000000000000000000000000000	GRAVEL
	CENTER LINE
	PROPERTY LINE
	LEASE LINE
	EASEMENT LINE
	RIGHTOF-WAY
xx	CHAIN LINK FENCE

WOOD FENCE SILT FENCE

BELOW GRADE

ELECTRIC

----UE----

BELOW GRADE ____UT____ TELEPHONE OVERHEAD -----OE/OT-----ELECTRIC/TELEPHONE

OVERHEAD TELEPHONE

OVERHEAD ELECTRIC CONTOUR -276----

TREE PROTECTION FENCE TREE LINE

TREES, SHRUBS, BUSHES

- NG --

SANITARY SEWER LINE WATER LINE

NATURAL GAS LINE



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A&E PROJECT #:	241149118
DRAWN BY:	JDS
CHECKED BY:	SM
REV. 1 BY:	VJS

REVISIONS		
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A	11/26/24	ISSUED FOR CONSTRUCTION
10	10/31/24	ISSUED FOR REVIEW
NO.	DATE	DESCRIPTION



SITE NAME:

MT JULIET

TN29593-S

ITE ADDRESS: 300 PLEASANT GROVE ROAD, SUITE 600 MOUNT JULIET, TN 37122

RAWLAND

ABBREVIATIONS & SYMBOLS LEGEND

Γ-2

GL

GLASS

2. ALL WORK PRESENTED ON THESE DRAWINGS MUST BE COMPLETED UNLESS NOTED OTHERWISE. THE CONTRACTOR MUST HAVE CONSIDERABLE EXPERIENCE IN PERFORMANCE OF WORK SIMILAR TO THAT DESCRIBED HEREIN. BY ACCEPTANCE OF THIS ASSIGNMENT, THE CONTRACTOR IS ATTESTING THAT HE DOES HAVE SUFFICIENT EXPERIENCE AND ABILITY. THAT HE IS KNOWLEDGEABLE OF THE WORK TO BE PERFORMED AND THAT HE IS LICENSED AND PROPERLY REGISTERED TO DO THIS WORK IN THE STATE AND/OR COUNTY IN WHICH IT IS TO BE PERFORMED.

UNLESS SHOWN OR NOTED OTHERWISE ON THE CONTRACT DRAWINGS, OR IN THE SPECIFICATIONS, THE FOLLOWING NOTES SHALL APPLY TO THE MATERIALS LISTED HEREIN, AND TO THE PROCEDURES TO BE USED ON THIS PROJECT.

4. ALL HARDWARE ASSEMBLY MANUFACTURER'S INSTRUCTIONS SHALL BE FOLLOWED EXACTLY AND SHALL SUPERCEDE ANY CONFLICTING NOTES ENCLOSED HEREIN.

IT IS THE CONTRACTOR'S SOLE RESPONSIBILITY TO DETERMINE ERECTION PROCEDURE AND SEQUENCE TO INSURE THE SAFETY OF THE STRUCTURE AND ITS COMPONENT PARTS DURING ERECTION AND/OR FIELD MODIFICATIONS. THIS INCLUDES, BUT IS NOT LIMITED TO, THE ADDITION OF WHATEVER TEMPORARY BRACING, GUYS OR TIE DOWNS THAT MAY BE NECESSARY. SUCH MATERIAL SHALL BE REMOVED AND SHALL REMAIN THE PROPERTY OF THE CONTRACTOR AFTER COMPLETION OF THE PROJECT

3. ALL DIMENSIONS, ELEVATIONS AND EXISTING CONDITIONS SHOWN ON THE DRAWINGS SHALL BE FIELD VERIFIED BY THE CONTRACTOR AND THE TESTING AGENCY PRIOR TO BEGINNING ANY MATERIALS ORDERING, FABRICATION OR CONSTRUCTION WORK ON THIS PROJECT. ANY DISCREPANCIES SHALL BE IMMEDIATELY BROUGHT TO THE ATTENTION OF THE OWNER AND THE OWNER'S ENGINEER. THE DISCREPANCIES MUST BE RESOLVED BEFORE THE CONTRACTOR IS TO PROCEED WITH THE WORK. THE CONTRACT DOCUMENTS DO NOT INDICATE THE METHOD OF CONSTRUCTION. THE CONTRACTOR SHALL SUPERVISE AND DIRECT THE WORK AND SHALL BE SOLELY RESPONSIBLE FOR ALL CONSTRUCTION MEANS, METHODS, TECHNIQUES, SEQUENCES AND PROCEDURES, OBSERVATION VISITS TO THE SITE BY THE OWNER AND/OR THE ENGINEER SHALL NOT INCLUDE INSPECTION OF THE PROTECTIVE MEASURES OR THE CONSTRUCTION PROCEDURES.

7. ALL MATERIALS AND EQUIPMENT FURNISHED SHALL BE NEW AND OF GOOD QUALITY, FREE FROM FAULTS AND DEFECTS AND IN CONFORMANCE WITH THE CONTRACT DOCUMENTS. ANY AND ALL SUBSTITUTIONS MUST BE PROPERLY APPROVED AND AUTHORIZED IN WRITING BY THE OWNER AND ENGINEER PRIOR TO INSTALLATION. THE CONTRACTOR SHALL FURNISH SATISFACTORY EVIDENCE AS TO THE KIND AND QUALITY OF THE MATERIALS AND EQUIPMENT BEING SUBSTITUTED.

THE CONTRACTOR SHALL BE RESPONSIBLE FOR INITIATING, MAINTAINING AND SUPERVISING ALL SAFETY PRECAUTIONS AND PROGRAMS IN CONNECTION WITH THE WORK. THE CONTRACTOR IS RESPONSIBLE FOR INSURING THAT THIS PROJECT AND RELATED WORK COMPLIES WITH ALL APPLICABLE LOCAL, STATE AND FEDERAL SAFETY CODES AND REGULATIONS GOVERNING THIS WORK

 ALL WORK SHALL BE COMPLETED IN ACCORDANCE WITH THE LATEST EDITION OF THE LOCAL BUILDING CODE.

10. ALL PROPOSED CELLULAR EQUIPMENT AND FIXTURES SHALL BE FURNISHED BY OWNER FOR INSTALLATION BY THE CONTRACTOR, UNLESS SPECIFICALLY NOTED OTHERWISE HEREIN.

11. ACCESS TO THE PROPOSED WORK SITE MAY BE RESTRICTED. THE CONTRACTOR SHALL COORDINATE INTENDED CONSTRUCTION ACTIVITY, INCLUDING WORK SCHEDULE AND MATERIALS ACCESS WITH THE RESIDENT LEASING AGENT FOR APPROVAL.

12. RADIO EQUIPMENT INSTALLATION SHALL BE IN ACCORDANCE WITH THE MANUFACTURER'S SPECIFICATIONS.

 DESIGN REQUIREMENTS PER LOCAL BUILDING CODE AND THE E1A/TIA-222-G STRUCTURAL STANDARDS FOR STEEL ANTENNAS TOWERS AND SUPPORTING STRUCTURES.

 STRUCTURAL STEEL SHALL CONFORM TO THE LATEST EDITION OF A.I.S.C. SPECIFICATIONS FOR STRUCTURAL STEEL BUILDINGS—ALLOWABLE STRESS DESIGN AND PLASTIC DESIGN INCLUDING THE COMMENTARY AND THE A.I.S.C. CODE OF STANDARD PRACTICE.

3. STRUCTURAL STEEL PLATES AND SHAPES SHALL CONFORM TO ASTM A36. ALL STRUCTURAL STEEL PIPES SHALL CONFORM TO ASTM A53 GRADE 8. ALL STRUCTURAL STEEL TUBING SHALL CONFORM TO ASTM A500 GRACE 8. ALL STRUCTURAL STEEL COMPONENTS AND FABRICATED ASSEMBLIES SHALL BE HOT DIP GALVANIZED AFTER FABRICATION.

 WELDING SHALL BE IN ACCORDANCE WITH THE AMERICAN WELDING SOCIETY (AWS) D.1.1—96. STRUCTURAL WELDING CODE—STEEL WELD ELECTRODES SHALL BE E70XX.

5. ALL COAXIAL CABLE CONNECTORS AND TRANSMITTER EQUIPMENT SHALL BE AS SPECIFIED BY THE OWNER AND IS NOT INCLUDED IN THESE CONSTRUCTION DOCUMENTS. THE CONTRACTOR SHALL FURNISH ALL CONNECTION HARDWARE REQUIRED TO SECURE THE CABLES. CONNECTION HARDWARE SHALL BE STAINLESS STEEL.

6. NORTH ARROW SHOWN ON PLANS REFERS TO TRUE NORTH.
CONTRACTOR SHALL VERIFY NORTH AND INFORM OWNER OF
ANY DISCREPANCY BEFORE STARTING CONSTRUCTION.

7. ALL CAST IN PLACE CONCRETE SHALL BE MIXED AND PLACED IN ACCORDANCE WITH THE REQUIREMENTS OF ACI 318 AND ACI 301, AND SHALL HAVE A 28 DAY MINIMUM COMPRESSIVE STRENGTH OF 4000 PSI (U.O.N.). CONCRETE SHALL BE PLACED AGAINST UNDISTURBED SOIL UNLESS OTHERWISE NOTED. MINIMUM CONCRETE COVER SHALL BE 3 INCHES UNLESS OTHERWISE NOTED.

8. ALL REINFORCING STEEL SHALL CONFORM TO ASTM 615

ALL REINFORCING STEEL SHALL CONFORM TO ASTM 615
 GRADE 80, DEFORMED BILLET STEEL BARS. WELDED WIRE
 FABRIC REINFORCING SHALL CONFORM TO ASTM A185.
 THE FABRICATION AND ERECTION OF STRUCTURAL STEEL

SHALL CONFORM TO THE LATEST A.I.S.C. SPECIFICATIONS.

10. ALL CONNECTIONS NOT FULLY DETAILED ON THESE PLANS SHALL BE DETAILED BY THE STEEL FABRICATOR IN

ACCORDANCE WITH A.I.S.C. SPECIFICATIONS.

11. HOT-DIP GALVANIZE ITEMS SPECIFIED TO BE ZINC-COATED.
AFTER FABRICATION WHERE PRACTICAL. GALVANIZING: ASTM
A 123, ASTM A 153/A 153M OR ASTM A 653/A 653M, G90,
AS APPLICABLE.

12. REPAIR DAMAGED SURFACES WITH GALVANIZING REPAIR
METHOD AND PAINT CONFORMING TO ASTM A 780 OR BY
APPLICATION OF STICK OR THICK PASTE MATERIAL
SPECIFICALLY DESIGNED FOR REPAIR OF GALVANIZING. CLEAN
AREAS TO BE REPAIRED, AND REMOVE SLAG FROM WELDS.
HEAT SURFACES TO WHICH STICK OR PASTE MATERIAL IS
APPLIED WITH A TORCH TO A TEMPERATURE SUFFICIENT TO
MELT THE METALLICS. IN STICK OR PASTE, SPREAD MOLTEN
MATERIAL UNIFORMLY OVER SURFACES TO BE COATED AND
WIPF OFF EXCESS MATERIAL.

13. CONTRACTOR SHALL FOLLOW THE MANUFACTURER'S INSTRUCTIONS/ SPECIFICATIONS IF NO INFORMATION IS CONTAINED IN THESE PLANS OR IF THE MANUFACTURER'S SPECIFICATIONS ARE STRICTER.

PERMITS

 CONTRACTOR SHALL SECURE ALL NECESSARY PERMITS FOR THIS PROJECT FROM ALL APPLICABLE GOVERNMENTAL AGENCIES. (NOT SUPPLIED BY OWNER)

2. ANY PERMITS WHICH MUST BE OBTAINED SHALL BE THE CONTRACTORS RESPONSIBILITY. THE CONTRACTOR SHALL BE RESPONSIBLE FOR ABIDING BY ALL CONDITIONS AND REQUIREMENTS OF THE PERMITS. (NOT SUPPLIED BY OWNER)

 ALL WORK SHALL BE IN ACCORDANCE WITH LOCAL CODES AND THE LATEST APPLICABLE CODES AND STANDARDS.

4. THE CONTRACTOR SHALL NOTIFY THE APPLICABLE JURISDICTIONAL (STATE, COUNTY, OR CITY) ENGINEER 24 HOURS PRIOR TO THE BEGINNING OF CONSTRUCTION.

 CONTRACTOR RESPONSIBLE FOR CLOSING AND FILING ALL PERMITS ASSOCIATED WITH SITE. 1. CONTRACTOR SHALL CONTACT A SUBSURFACE UTILITY
LOCATOR FOR LOCATION OF EXISTING UTILITIES PRIOR TO
COMMENCEMENT OF ANY CONSTRUCTION ACTIVITIES.
LOCATION OF EXISTING SEWER, WATER LINES, GAS LINES,
CONDUITS OR OTHER STRUCTURES ACROSS, UNDERNEATH, OR
OTHERWISE ALONG THE LINE OF PROPOSED WORK ARE NOT
NECESSARILY SHOWN ON THE PLANS, AND IF SHOWN ARE
ONLY APPROXIMATELY CORRECT. CONTRACTOR ASSUMES SOLE
RESPONSIBILITY FOR VERIFYING LOCATION AND ELEVATION OF
ALL UNDERGROUND UTILITIES (INCLUDING TEST PITS BY HAND
IF NECESSARY) IN AREAS OF CONSTRUCTION PRIOR TO
STARTING WORK. CONTACT ENGINEER IMMEDIATELY IF LOCATION
DR ELEVATION IS DIFFERENT FROM THAT SHOWN ON THE
PLANS. OR IF THERE APPEARS TO BE A CONFLICT.

 CONTRACTOR SHALL COORDINATE ALL UTILITY CONNECTIONS WITH APPROPRIATE UTILITY OWNERS AND CONSTRUCTION MANAGER.

3. DAMAGE BY THE CONTRACTOR TO UTILITIES OR PROPERTY OF OTHERS, INCLUDING EXISTING PAVEMENT AND OTHER SURFACES DISTURBED BY THE CONTRACTOR DURING CONSTRUCTION SHALL BE REPAIRED TO PRE CONSTRUCTION CONDITIONS BY THE CONTRACTOR AT NO ADDITIONAL COST TO THE CLIENT. FOR GRASSED AREAS, SEED AND MULCH SHALL BE ACCEPTABLE.

4. THE CONTRACTOR SHALL COORDINATE WITH THE OWNER THE REQUIREMENTS FOR AND LIMITS OF OVERHEAD AND/OR UNDERGROUND ELECTRICAL SERVICE.

5. THE CONTRACTOR SHALL COORDINATE THE LOCATION OF NEW UNDERGROUND TELEPHONE SERVICE WITH THE TELEPHONE UTILITY AND THE OWNER'S REQUIREMENTS.

6. ALL UNDERGROUND UTILITIES SHALL BE INSTALLED AND TESTED SATISFACTORY PRIOR TO COMMENCING ANY PAVING OPERATIONS WHERE SUCH UTILITIES ARE WITHIN THE LIMITS OF PAVEMENT.

GRADING

- 1. THE CONTRACTOR SHALL REWORK (DRY, SCARIFY, ETC...) ALL MATERIAL NOT SUITABLE FOR SUB GRADE IN ITS PRESENT STATE. IF THE MATERIAL, AFTER REWORKING, REMAINS UNSUITABLE THEN THE CONTRACTOR SHALL UNDERCUT THIS MATERIAL AND REPLACE WITH APPROVED MATERIAL AT HIS EXPENSE. ALL SUB GRADES SHALL BE PROOF ROLLED WITH A FULLY LOADED TANDEM AXLE DUMP TRUCK PRIOR TO PAVING. ANY SOFT MATERIAL SHALL BE REWORKED OR REPLACED.
- 2. THE CONTRACTOR IS REQUIRED TO MAINTAIN ALL DITCHES, PIPES, AND OTHER DRAINAGE STRUCTURES FREE FROM OBSTRUCTION UNTIL WORK IS ACCEPTABLE BY THE OWNER. THE CONTRACTOR IS RESPONSIBLE FOR ANY DAMAGES CAUSED BY FAILURE TO MAINTAIN DRAINAGE STRUCTURES IN OPERABLE CONDITION.
- ALL MATERIALS AND WORKMANSHIP SHALL BE WARRANTED FOR ONE (1) YEAR FROM DATE OF ACCEPTANCE.
- 4. ALL DIMENSIONS SHALL BE VERIFIED WITH THE PLANS (LATEST REVISION) PRIOR TO COMMENCING CONSTRUCTION. NOTIFY THE OWNER IMMEDIATELY IF DISCREPANCIES ARE DISCOVERED. THE CONTRACTOR SHALL HAVE A SET OF APPROVED PLANS AVAILABLE AT THE SITE AT ALL TIMES WHEN WORK IS BEING PRE FORMED. A DESIGNATED RESPONSIBLE EMPLOYEE SHALL BE AVAILABLE FOR CONTACT BY GOVERNING AGENCY INSPECTORS.

 AWARDED CONTRACTOR WILL BE REQUIRED TO SIGN AND RETURN A COPY OF AN AWARD LETTER FOR SBA'S FILE.

CONTRACTOR WILL BE REQUIRED TO PROVIDE PROOF OF LICENSE TO PERFORM WORK IN JURISDICTION AT TIME OF BID AWARD.

 CONTRACTOR WILL PROVIDE A CONSTRUCTION SCHEDULE PRIOR TO CONSTRUCTION STARTING AND WILL PROVIDE UPDATE/CHANGES (WITH EXPLANATIONS) TO THAT SCHEDULE WHEN/IF ITEMS ARE DELAYED OR PUSHED OUT.

 CONTRACTOR WILL BE RESPONSIBLE FOR ALL CONCRETE COMPRESSIVE TESTING AND REQUIRED TO SUBMIT FINAL TEST RESULTS WITH CLOSE OUT BOOK.

 CONTRACTOR WILL BE RESPONSIBLE TO PROVIDE SBA PROJECT MANAGERS WITH PHOTOS OF THE MAJOR CONSTRUCTION MILESTONES AS THEY OCCUR.

6. CONTRACTOR WILL BE RESPONSIBLE TO ASSIST IN COORDINATING AND OBTAINING PRIMARY POWER TO THE SITE PRIOR TO TOWER ERECTION, AS WELL AS TELCO SERVICE BEFORE PROJECT COMPLETION. (ON SITE VISITS WITH UTILITY COMPANY REPRESENTATIVES AS NECESSARY, ETC....).

7. CONTRACTOR WILL HAVE A REPRESENTATIVE ON A WEEKLY CONFERENCE CALL TO PROVIDE SBA WITH SITE SPECIFIC UPDATES. CURRENTLY, THIS CONFERENCE CALL IS HELD EACH AND EVERY THURSDAY AT 4 PM (EASTERN TIME).

8. CONTRACTOR SHOULD BE PREPARED FOR RANDOM SBA SAFETY INSPECTIONS AT ALL TIMES.

 CONTRACTOR IS EXPECTED TO MAINTAIN PROPER WORKING CONDITIONS AND PROCEDURES PER OSHA STANDARDS AT ALL TIMES.

 CONTRACTOR WILL BE REQUIRED TO OBTAIN THE NECESSARY ELECTRICAL PERMITS AND INSPECTIONS AS REQUIRED BY JURISDICTION.

 CONTRACTOR IS EXPECTED TO CLOSE—OUT THE JOB SITE AS QUICKLY AS POSSIBLE (OBTAINING A CERTIFICATE OF OCCUPANCY AND GETTING SBA'S REGIONAL SITE MANAGER'S SIGN—OFF/CHECKLIST APPROVAL ON THE SITE).

SIGN-OFF/CHECKLIST APPROVAL ON THE SITE).
2. CONTRACTOR WILL PROVIDE A COMPLETED TOWER HEIGHT VERIFICATION FORM AND TAPE DROP WITHIN 24 HOURS OF REACHING OVERALL HEIGHT.

13. CONTRACTOR WILL UTILIZE ALL OF THE SBA PROVIDED DOCUMENTATION INCLUDING BUT NOT LIMITED TO: TOWER CONSTRUCTION ACCEPTANCE CHECKLIST, CONSTRUCTION SCHEDULE, CONSTRUCTION CLOSE—OUT LIST & TOWER HEIGHT VERIFICATION.

14. CONTRACTOR IS RESPONSIBLE FOR CONCRETE COMPRESSION

 CONTRACTOR IS RESPONSIBLE FOR GROUND MEG TESTING.
 CONTRACTOR IS RESPONSIBLE FOR ALL GRADING AND FILL COMPACTION TESTING REQUIRED AS SET FORTH IN THE GEO

TECHNOLOGICAL REPORT PROVIDED BY OWNER.

SBA D

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A&E PROJECT #:	241149118
DRAWN BY:	JDS
CHECKED BY:	SM
REV. 1 BY:	VJS

ı	REVISIONS			
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١	二			
-	A	11/26/24	ISSUED FOR	CONSTRUCTION
- 1	10	10/31/24	ISSUED FOR	REVIEW
- 1	NO.	DATE	DESCRIPTION	
- 1			70 H-200 - 10	



SITE NAME:

MT JULIET

TE NUMBER:

TN29593-S

SITE ADDRESS:
300 PLEASANT GROVE ROAD,
SUITE 600
MOUNT JULIET, TN 37122

RAWLAND

SHEET TITLE:

GENERAL NOTES

GN-1

| 1

GEOTECHNICAL NOTES

- 1. THE SITE SHALL BE CLEARED BY MEANS OF REMOVING TREES, TREE STUMPS, SURFACE VEGETATION AND TOPSOIL MATERIALS. IT'S RECOMMENDED THAT CLEARING EXTEND AT LEAST 5 FEET BEYOND PLANNED BUILDING AREAS AND AREAS TO RECEIVE COMPACTED FILL. IN PREPARATION FOR FILL PLACEMENT, AREAS SHALL BE LEVELED OUT TO FACILITATE THE PLACEMENT OF FILL IN HORIZONTAL LIFTS. THIS SHALL BE ACHIEVED BY CUTTING INTO THE UPHILL SIDE OF AREAS TO RECEIVE FILL. AREAS TO RECEIVE FILL SHALL BE EVALUATED BY A GEOTECHNICAL ENGINEER TO VERIFY THAT THEY ARE IN FIRM, RELATIVELY DRY AND SUITABLE FOR FILL PLACEMENT.
- 2. WITH THE EXCEPTION OF THE UPPER 2 FEET BENEATH PLANNED FOUNDATIONS AND BUILDING PADS, FILL MATERIALS SHALL BE COMPACTED TO AT LEAST 95 PERCENT OF THE MAXIMUM DRY DENSITY AS DETERMINED BY THE STANDARD PROCTOR METHOD (ASTM D-698), FILL WITHIN THE UPPER 2 FEET BENEATH PLANNED FOUNDATIONS AND BUILDING PADS SHALL BE COMPACTED TO AT LEAST 98% OF THE MAXIMUM DRY DENSITY AS DETERMINED BY THE STANDARD PROCTOR METHOD (ASTM D-698).
- 3. TO ACCOMPLISH THIS, IT IS RECOMMENDED THAT FILL SOIL MOISTURE CONTENTS BE MAINTAINED WITHIN 3 PERCENTAGE POINTS OF THE OPTIMUM MOISTURE CONTENT AS DETERMINED BY THE STANDARD PROCTOR METHOD (ASTM D698). SOILS WITH EXCESSIVE MOISTURE SHALL BE SCARIFIED, DISCED, AND DRIED DURING THE WARMER DRYER MONTHS TO REDUCE THE MOISTURE CONTENT, AND MOISTURE SHALL BE ADDED TO INCREASE THE MOISTURE CONTENT.
- 4. TO ACHIEVE PROPER COMPACTION, SUITABLE MOISTURE CONDITIONED FILL MATERIALS SHALL BE PLACED IN HORIZONTAL LOOSE LIFTS (8 INCHES LOOSE IF LARGE COMPACTION EQUIPMENT IS USED, 4 INCHES IF SMALLER WALK—BEHIND EQUIPMENT IS TO BE USED). IF SANDY SOILS ARE ENCOUNTERED COMPACTION WITH A HEAVY SMOOTH DRUM SHALL BE USED. IF CLAY OR SILT SOILS ARE ENCOUNTERED A SHEEPSFOOT ROLLER SHALL BE MORE EFFECTIVE ACHIEVING COMPACTION.
- 5. IN-PLACE DENSITY TESTS SHALL BE PERFORMED TO VERIFY COMPACTION OF THE FILL MATERIALS. THESE TESTS ARE GENERALLY PERFORMED AT A FREQUENCY OF ONE TEST PER 2,500 SQUARE FEET AND ON EACH FOOT OF FILL BEING PLACED.
- 6. FOUNDATIONS FOR LIGHTLY LOADED STRUCTURES (IE. GENERATORS AND EQUIPMENT SHELTERS) SHALL BE DESIGNED TO BEAR IN THE NEWLY PLACED, COMPACTED FILL. FOUNDATIONS FOR LIGHTLY LOADED STRUCTURES SET IN FILL SHALL BE DESIGNED TO BEAR AT LEAST 2 FEET BELOW THE FINISHED GROUND SURFACE, TO HAVE A MINIMUM FOOTING WIDTH OF 1B INCHES, AND WITH A GROSS ULTIMATE BEARING PRESSURE OF 6000 PSF, PROVIDED THAT FILL MATERIALS ARE VERIFIED AS BEING SUITABLE, AND COMPACTED AS RECOMMENDED IN THESE NOTES.



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MT JULIET

SITE NUMBER:

TN29593-S

SITE ADDRESS:
300 PLEASANT GROVE ROAD,
SUITE 600
MOUNT JULIET, TN 37122

RAWLAND


SHEET TITLE

GENERAL NOTES

HEET NUMBER: REVISION

GN-2

PARENT PARCEL DETAIL

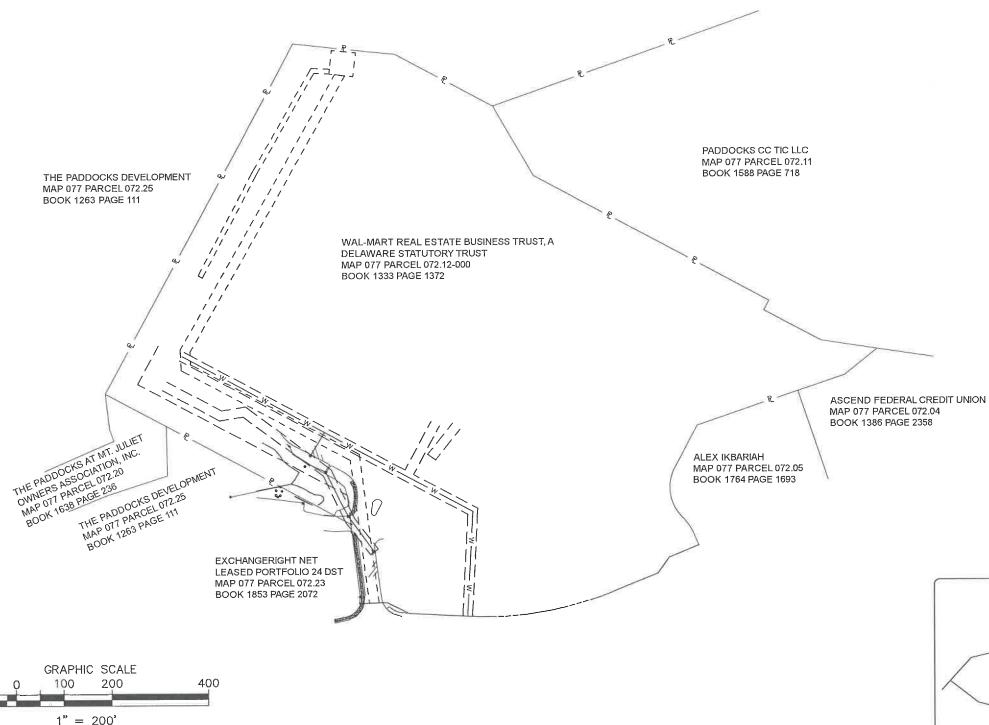

100

LEGEND

© :COMMUNICATION BOX

Ф	:MAG NAIL (FOUND)	P.O.B.	:POINT OF BEGINNING
	:IRON PIN (FOUND)	P.O.C.	:POINT OF COMMENCEMENT
9	:STORM MANHOLE	R.O.W.	:RIGHT-OF-WAY
0	:BOLLARD	C.M.P.	:CORRUGATED METAL PIPE
1000	:DROP INLET	x	:FENCE AS NOTED
(5)	:SEWER MANHOLE	ST	:UNDERGROND STORM LINE
O	:FIRE HYDRANT		:CENTERLINE
ø	:POWER POLE	t	:PARENT PARCEL LINE
101	:AREA LIGHT	RW	:RIGHT-OF-WAY LINE
	:SIGN POST		:EASEMENT LINE
G	:GAS METER	645	:CONTOUR LINE
\bowtie	:WATER VALVE	EU	:UNDERGROUND ELECTRIC LIN

AS-BUILT SURVEY

WILSON COUNTY, TN TAX ID: 077 072.12

SBA SITE #: TN29593-S SITE NAME: WM 4482 MT. JULIET TN ADDRESS:

300 PLEASANT GROVE RD. STE 600 MT. JULIET, TN 37122



SBA NETWORK SERVICES, LLC 8051 CONGRESS AVE. BOCA RATON, FL 33487

SURVEYOR'S CERTIFICATION I HEREBY CERTIFY TO: SBA TOWERS X, LLC, A DELAWARE LIMITED LIABILITY COMPANY AND FIDELITY NATIONAL TITLE INSURANCE COMPANY, TITLE COMMITMENT NO. 5000001720, EFFECTIVE DATE 10-10-23



Date: 10-27-23
Revised:

A. LEO
LAWO
MM E R

OMM E R

SURVEY WORK PERFORMED BY:



LICENSED IN TN, KY, & AL.

1198 OLD PINNACLE RD. JOELTON, TN 37080

1198 OLD PINNACLE RD. JOELION, IN 37080 PHONE: (615) 212-5703 E-MAIL: b2lhps@gmail.com


DRAWN BY: CB | CHECKED BY: JL | JOB #: LS-1794


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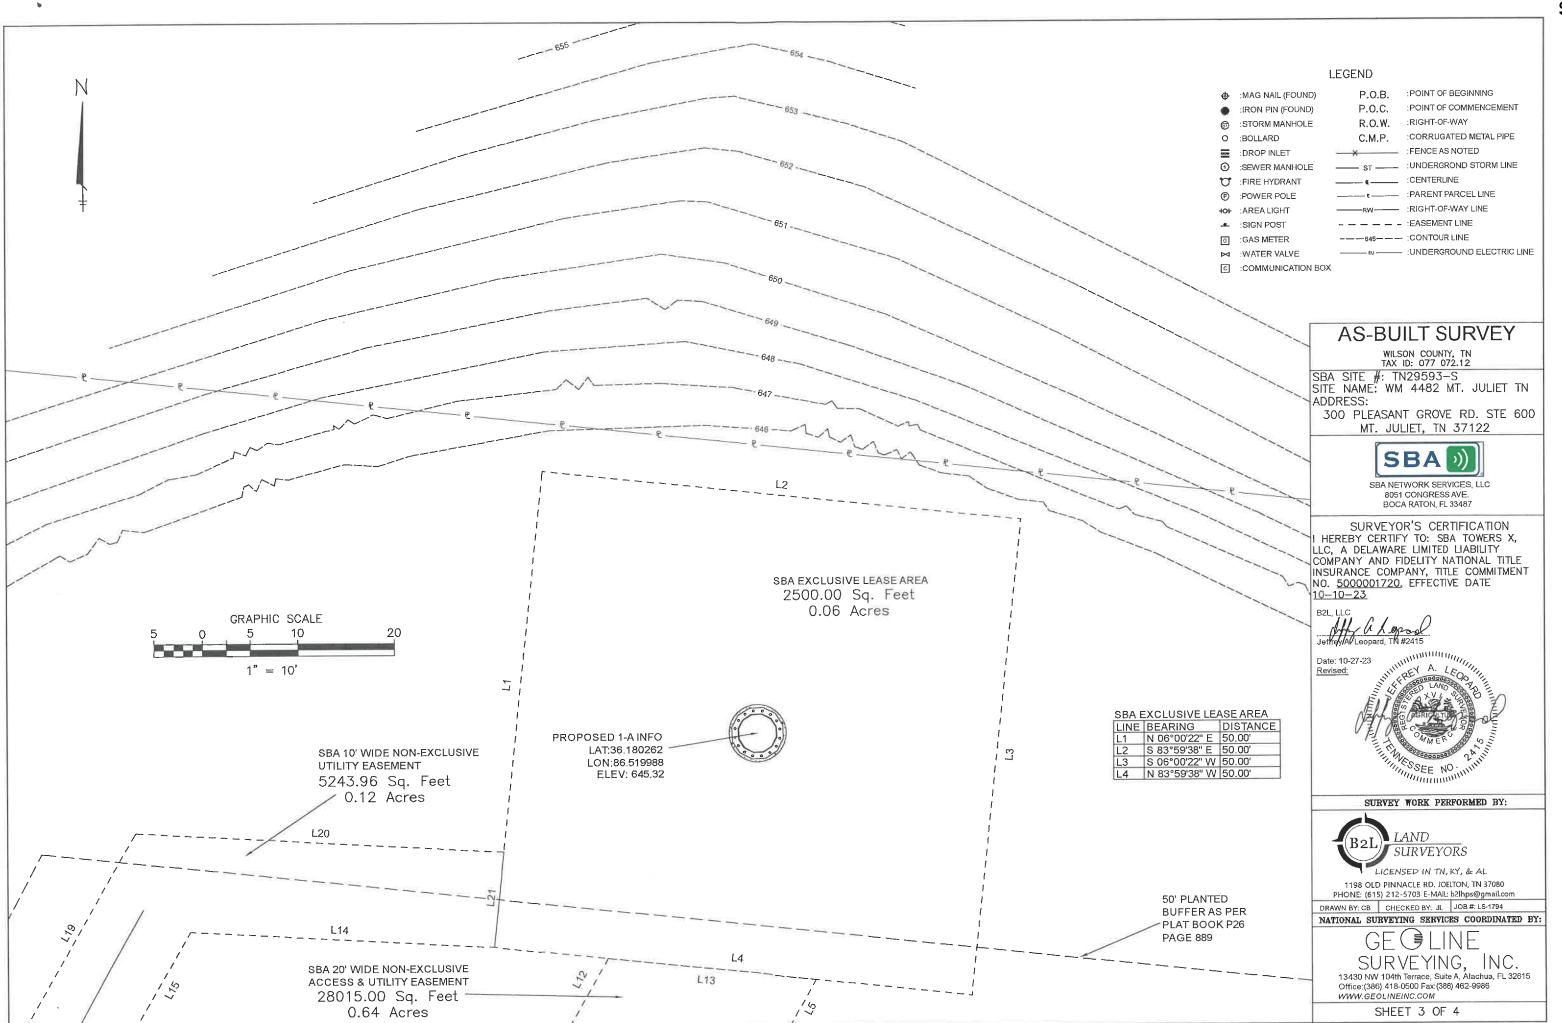
GE GLINE SURVEYING. IN

SURVEYING, INC. 13430 NW 104th Terrace, Suite A, Alachua, FL 32615 Office:(386) 418-0500 Fax:(386) 462-9986 WWW.GEOLINEINC.COM

SHEET 1 OF 4



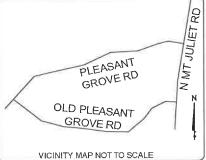

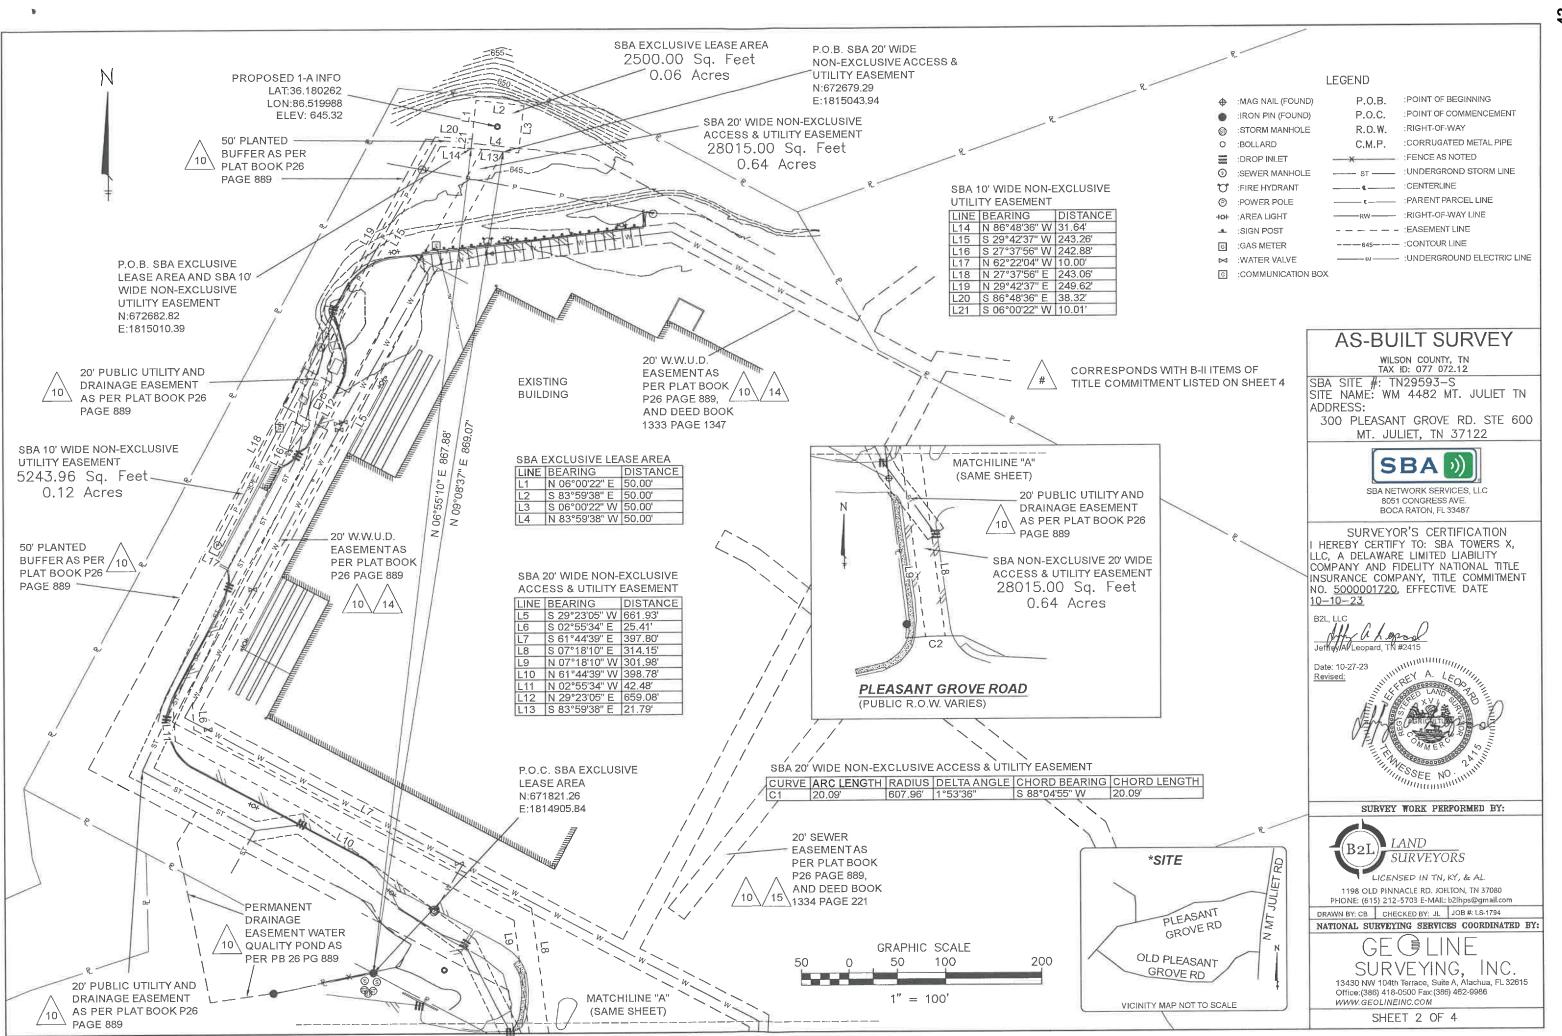

EXCLUSIVE LEASE AREA LEGAL DESCRIPTION (AS SURVEYED)

Situated in Wilson County, Tennessee, and being more particularly described as follows:

COMMENCING at an iron (found) in the northerly line of the Exchangeright Net Leased Portfolio 24 DST property (Book 1853 Page 2072), located at Tennessee State Plane Coordinates N: 671821.26 E: 1814905.84, thence. North 06 degrees 55 minutes 10 seconds East, 867.88 feet to Tennessee State Plane Coordinates N: 672682.82 E: 1815010.39, this being the TRUE POINT OF BEGINNING:

Thence, North 06 degrees 00 minutes 22 seconds East, 50.00 feet;

Thence, South 83 degrees 59 minutes 38 seconds East, 50.00 feet;

Thence, South 06 degrees 00 minutes 22 seconds West 50.00 feet;

Thence, North 83 degrees 59 minutes 38 seconds West, 50.00 feet to the POINT OF BEGINNING. Containing 2,500.00 square feet or 0.06 acres, more or less.

OWNER: WAL-MART REAL ESTATE BUSINESS TRUST, A DELAWARE STATUTORY TRUST PARCEL ID: MAP 077 PARCEL 072.12-000 DEED REFERENCE: BOOK 1333 PAGE 1372

20' WIDE NON-EXCLUSIVE ACCESS & UTILITY EASEMENT LEGAL DESCRIPTION (AS SURVEYED)

Situated in Wilson County, Tennessee, and being more particularly described as follows:

COMMENCING at an iron (found) in the northerly line of the Exchangeright Net Leased Portfolio 24 DST property (Book 1853 Page 2072), located at Tennessee State Plane Coordinates N: 671821.26 E: 1814905.84, thence, North 55 degrees 23 minutes 48 seconds East, 69.77 feet to Tennessee State Plane Coordinates N: 671860.88 E: 1814963.26, this being the TRUE POINT OF BEGINNING;

Thence, South 29 degrees 23 minutes 05 seconds West, 661.93 feet;

Thence, South 02 degrees 55 minutes 34 seconds East, 25.41 feet;

Thence, South 61 degrees 44 minutes 39 seconds East, 397.80 feet;

Thence, South 07 degrees 18 minutes 10 seconds East, 314.15 feet;

Thence, with a curve to the left, having an arc length of 20.09 feet, a radius of 607.96 feet, a chord bearing of South 88 degrees 04 minutes 55 seconds West, a chord length of 20.08 feet;

Thence, North 07 degrees 18 minutes 10 seconds West 301.98 feet;

Thence, North 61 degrees 44 minutes 39 seconds West, 398.78 feet;

Thence, North 02 degrees 55 minutes 34 seconds West, 42.48 feet;

Thence, North 29 degrees 23 minutes 05 seconds East, 659.08 feet;

Thence, South 83 degrees 59 minutes 38 seconds East, 21.79 feet to the POINT OF BEGINNING. Containing 28,015.00 square feet or 0.64 acres, more or less.

OWNER: WAL-MART REAL ESTATE BUSINESS TRUST, A DELAWARE STATUTORY TRUST PARCEL ID: MAP 077 PARCEL 072.12-000 DEED REFERENCE: BOOK 1333 PAGE 1372

10' WIDE NON-EXCLUSIVE UTILITY EASEMENT LEGAL DESCRIPTION (AS SURVEYED)

Situated in Wilson County, Tennessee, and being more particularly described as follows:

COMMENCING at an iron (found) in the northerly line of the Exchangeright Net Leased Portfolio 24 DST property (Book 1853 Page 2072), located at Tennessee State Plane Coordinates N: 671821.26 E: 1814905.84, thence, North 06 degrees 55 minutes 10 seconds East, 867.88 feet to Tennessee State Plane Coordinates N: 672682.82 E: 1815010.39, this being the TRUE POINT OF BEGINNING:

Thence, North 86 degrees 48 minutes 36 seconds West, 31.64 feet;

Thence, South 29 degrees 42 minutes 37 seconds West, 243.26 feet;

Thence, South 27 degrees 37 minutes 56 seconds West 242.88 feet;

Thence, North 62 degrees 22 minutes 04 seconds West, 10.00 feet;

Thence, North 27 degrees 37 minutes 56 seconds East, 243.06 feet;

Thence, North 29 degrees 42 minutes 37 seconds East, 249.62 feet;

Thence, South 86 degrees 48 minutes 36 seconds East, 38.32 feet;

Thence, South 06 degrees 00 minutes 22 seconds West, 10.01 feet to the POINT OF BEGINNING. Containing 5,243.96 square feet or 0.12 acres, more or less.

OWNER: WAL-MART REAL ESTATE BUSINESS TRUST, A DELAWARE STATUTORY TRUST PARCEL ID: MAP 077 PARCEL 072.12-000 DEED REFERENCE: BOOK 1333 PAGE 1372

PARENT PARCEL LEGAL DESCRIPTION (AS PROVIDED)

An interest in land, said interest being over a portion of the following described parent parcel:

A tract of land lying in the 25th Civil District of Mt. Juliet, Wilson County, Tennessee, being Lot No. 12 on the Final Plat of The Paddocks at Mt. Juliet, Phase I, which plat is of record in Plat Book P26, Page 889, Register's Office for Wilson County, Tennessee.

AND BEING the same property conveyed to Wal-Mart Real Estate Business Trust, a Delaware statutory trust from The Paddocks Development, L.P., a Delaware limited partnership by Special Warranty Deed dated December 19, 2008 and recorded January 14, 2009 in Deed Book 1333, Page 1372.

Tax Parcel No. 077-072.12-000

TITLE INSURANCE COMMITMENT NOTE:

I HAVE REVIEWED COMMITMENT FOR TITLE INSURANCE, UNDERWRITTEN BY FIDELITY NATIONAL TITLE INSURANCE COMPANY, WITH AN EFFECTIVE DATE OF OCTOBER 10, 2023 COMMITMENT NUMBER 5000001720, AND FIND AS FOLLOWS WITH RESPECT TO THE EXCEPTIONS LISTED IN SCHEDULE B-SECTION 2 OF SAID COMMITMENT:

ITEMS 1-7 ARE STANDARD EXCEPTIONS AND ARE NOT THE TYPE TO BE DEPICTED HEREON.

8. Matters as shown and noted on Plat recorded in Plat Book P25, Page 967. (APPARENTLY VOIDED, VACATED, AND SUPERSEDED BY SUBSEQUENT PLATS) 9, Matters as shown and noted on Plat recorded in Plat Book P25, Page 968. PPARENTLY VOIDED, VACATED, AND SUPERSEDED BY SUBSEQUENT PLATS) 10. Matters as shown and noted on Plat recorded in Plat Book P26, Page 889. (AFFECTS PARENT PARCEL, ALL MATTERS SHOWN HEREON)

11. Storm Water Maintenance Agreement dated September 27, 2007, by and between The Paddocks Development, LP and The City of Mt. Juliet, recorded on October 10, 2007 in Deed Book 1274, Page 1812. (BLANKET IN NATURE, AFFECTS PARENT PARCEL. NOT THE TYPE TO BE DEPICTED HEREON)

12. Storm Water Detention Agreement dated September 27, 2007, by and between The Paddocks Development, LP and The City of Mt. Juliet, recorded on October 10, 2007 in Deed Book 1274, Page 1816. (BLANKET IN NATURE, AFFECTS PARENT PARCEL. NOT THE TYPE TO BE DEPICTED HEREON)

13. Declaration of Covenants, Conditions and Restrictions for the Paddocks at Mt. Juliet recorded on January 14, 2009 in Deed Book 1333, Page 1291; AMENDED BY First Amendment to Declaration of Covenants, Conditions and Restrictions for the Paddocks at Mt. Juliet recorded on July 23, 2009 in Deed Book 1363, Page 2044; AMENDED BY Second Amendment to Declaration of Covenants, Conditions and Restrictions for the Paddocks at Mt. Juliet recorded on February 10, 2010 in Deed Book 1386, Page 2344; AMENDED BY Third Amendment to Declaration of Covenants. Conditions and Restrictions for the Paddocks at Mt. Juliet recorded on March 9, 2012 in Deed Book 1477, Page 1962; AMENDED BY Fourth Amendment to Declaration of Covenants, Conditions and Restrictions for the Paddocks at Mt. Juliet recorded on March 3, 2015 in Deed Book 1630, Page 1003;

AMENDED BY Fifth Amendment to Declaration of Covenants, Conditions and Restrictions for the Paddocks at Mt. Juliet recorded on September 5, 2019 in Deed Book 1904. Page 47: AMENDED BY Sixth Amendment to Declaration of Covenants, Conditions and Restrictions for the Paddocks at Mt. Juliet recorded on July 7, 2021 in Deed Book 2083, Page 614. (BLANKET IN NATURE, AFFECTS PARENT PARCEL. NOT PLOTTABLE)

14 Easement Agreement in favor of West Wilson Utility District of Wilson County, Tennessee set forth in instrument recorded on January 14, 2009 in Deed Book 1333, Page 1347, (AFFECTS PARENT PARCEL, DOES NOTAFFECT PROPOSED SBA LEASE AREA OR 20' WIDE NON-EXCLUSIVE ACCESS & UTILITY EASEMENT AREA, AS SHOWN HEREON AS SHOWN HEREON)

/15. Agreement for Dedication of a Sanitary Sewer Easement by and between Wal-Mart Real Estate Business Trust, as Grantor, and The City of Mt. Juliet, Tennessee, as Grantee, recorded on January 14, 2009 in Deed Book 1333, Page 1450. (AFFECTS PARENT PARCEL, DOES NOT AFFECT PROPOSED SBA LEASE AREA OR 20' WIDE NON-EXCLUSIVE ACCESS & UTILITY EASEMENT AREA, AS SHOWN HEREON) 16. Performance Bond, by and between Vratsinas Construction Company, Travelers Casualty and Surety Company of America and Wal-Mart Stores, Inc., recorded on January 20, 2009 in Deed Book 1334, Page 221, in the original amount of \$5,835,970.00. (BLANKET IN NATURE, NOT THE TYPE TO BE DEPICTED HEREON)



CORRESPONDS WITH B-II ITEMS OF TITLE COMMITMENT LISTED ON SHEET 2

AS-BUILT SURVEY

WILSON COUNTY, TN TAX ID: 077 072.12

SBA SITE #: TN29593-S SITE NAME: WM 4482 MT, JULIET TN ADDRESS:

300 PLEASANT GROVE RD. STE 600 MT. JULIET, TN 37122



SBA NETWORK SERVICES, LLC 8051 CONGRESS AVE. BOCA RATON, FL 33487

SURVEYOR'S CERTIFICATION HEREBY CERTIFY TO: SBA TOWERS X, LLC. A DELAWARE LIMITED LIABILITY COMPANY AND FIDELITY NATIONAL TITLE INSURANCE COMPANY, TITLE COMMITMENT NO. 5000001720, EFFECTIVE DATE 10-10-23



Date: 10-27-23



SURVEY WORK PERFORMED BY:




1198 OLD PINNACLE RD. JOELTON, TN 37080 PHONE: (615) 212-5703 E-MAIL: b2lhps@gmail.com

DRAWN BY: CB CHECKED BY: JL JOB #: LS-1794 NATIONAL SURVEYING SERVICES COORDINATED BY:



13430 NW 104th Terrace, Suite A, Alachua, FL 32615 Office:(386) 418-0500 Fax:(386) 462-9986 WWW.GEOLINEINC.COM

SHEET 4 OF 4

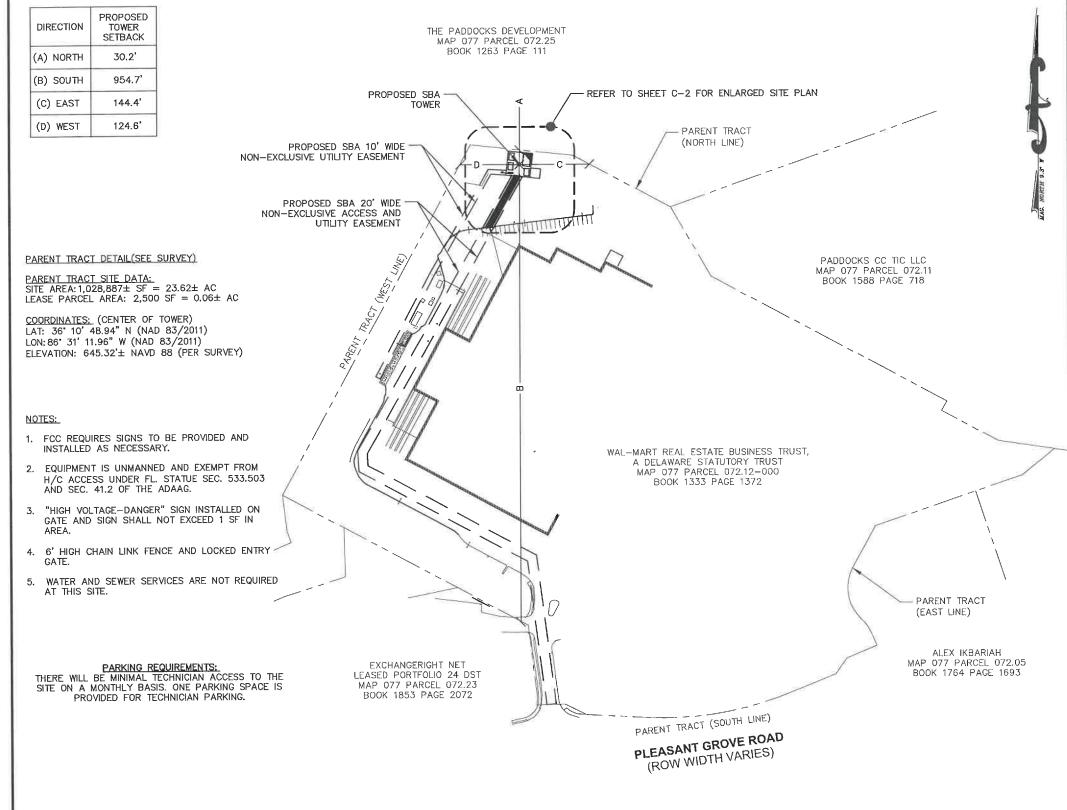

- FENCED SITE AREA SHALL BE CLEARED AND GRUBBED. REMOVE UNSUITABLE SOFT OR LOOSE SOILS, ORGANIC MATERIAL AND OR RUBBLE TO FIRM SUBGRADE. FILL UNDERCUT UP TO 6 INCHES BELOW FINISH GRADE.
- THE CONTRACTOR MUST CONTACT THE SURVEYOR TO STAKE OUT THE LEASE AREA AND ALL EASEMENTS PRIOR TO CONSTRUCTION. ALL FEES ARE THE RESPONSIBILITY OF THE
- IF ANY ARCHAEOLOGICAL MATERIALS ARE ENCOUNTERED DURING CONSTRUCTION, THE CONTRACTOR SHALL STOP WORK IMMEDIATELY AND NOTIFY THE CLIENT.
- THE CONTRACTOR IS TO ENSURE THAT NO DAMAGE OR DEBRIS OCCURS ON THE ADJACENT PROPERTIES.
- THE CONTRACTOR SHALL SEED ALL DISTURBED AREAS WITH LOW MAINTENANCE NATIVE GRASS AND COVER WITH APPROVED STRAW.
- UNTIL THE COMPOUND IS SURROUNDED BY A PERMANENT FENCE, THE CONTRACTOR MUST ERECT A TEMPORARY FENCE AROUND THE TOWER AND POST A "NO TRESPASSING" SIGN. ALL CLIMBING PEGS MUST BE REMOVED UP TO 20' UNTIL A PERMANENT FENCE IS INSTALLED.
- THE CONTRACTOR MUST ENSURE THAT ALL DELIVERY TRUCKS WILL BE ABLE TO DELIVER THE MATERIAL TO THE COMPOUND. IF THE DELIVERY TRUCKS CAN NOT ACCESS THE COMPOUND THEN THE CONTRACTOR MUST MAKE OTHER ARRANGEMENTS TO GET THE MATERIAL TO THE COMPOUND. IF THIS IS REQUIRED THE CONTRACTOR MUST CONTACT KIMLEY-HORN AND ASSOCIATES IMMEDIATELY. NO ADDITIONAL FEES WILL BE PASSED ON TO THE CLIENT.
- PROPOSED TOWER AND FOUNDATION TO BE INSTALLED IN ACCORDANCE WITH THE TOWER MANUFACTURER PLANS PROVIDED BY CLIENT. THE CONTRACTOR SHALL BE RESPONSIBLE FOR THE UNLOADING OF TOWER MATERIALS DELIVERED TO SITE BY THE TOWER MANUFACTURER.
- CONTRACTOR MUST REFER TO THE GEOTECH REPORT FOR ALL COMPACTED FILL RECOMMENDATIONS. IF THE GEOTECH REPORT CONFLICTS WITH THE CONSTRUCTION DRAWINGS THEN STOP WORK AND CONTACT THE CLIENT AS SOON AS
- 10. IT IS THE CONTRACTORS RESPONSIBILITY TO VERIFY ALL DOT AND/OR COUNTY SPECIFICATIONS PRIOR TO BID AND CONSTRUCTION. IF THE SPECIFICATIONS DIFFER FROM THE CONSTRUCTION DRAWINGS, THEN THE SPECIFICATIONS WILL GOVERN. NO ADDITIONAL COSTS FOR ADHERING TO THE SPECIFICATIONS WILL BE ALLOWED AFTER THE BID HAS BEEN ISSUED AND ACCEPTED NOR WILL PROJECT DELAYS BE TOLERATED.
- 11. AT THE TIME THE CONSTRUCTION DRAWINGS WERE COMPLETED, KIMLEY-HORN AND ASSOCIATES DID NOT HAVE A COPY OF THE PROPOSED TOWER MANUFACTURER DRAWINGS THUS WE DO NOT KNOW THE EXACT SIZE OF THE OVERALL TOWER FOOTPRINT. THE CONTRACTOR MUST COMPARE THE CONSTRUCTION DRAWINGS WITH THE TOWER DRAWINGS PRIOR TO BID AND/OR CONSTRUCTION AND IF THEY FIND ANY DISCREPANCIES OR POSSIBLE ISSUES THEY MUST NOTIFY THE CLIENT IMMEDIATELY.

GRAPHIC SCALE

SCALE: 1" = 200



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|Kimley » Horn

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THE INFORMATION CONTAINED IN THIS SET OF DOCUMENTS IS PROPRIETARY OTHER THAN THAT WHICH RELATES TO THE CLIENT IS STRICTLY PROHIBITED

A&E PROJECT #:	241149118
DRAWN BY:	JDS
CHECKED BY:	SM
REV. 1 BY:	VJS

	REVISIONS			
		ISSUED FOR CONSTRUCTION		
A	10/31/24	ISSUED FOR REVIEW		
NO.	DATE	DESCRIPTION		



MT JULIET

TN29593-S

300 PLEASANT GROVE ROAD, SUITE 600 MOUNT JULIET, TN 37122

RAWLAND

400

OVERALL SITE PLAN

SHEET NUMBER


REVISION

FLOOD ZONE INFORMATION:

FLOOD ZONE:

47189C0142E PANEL NUMBER:

EFFECTIVE DATE: 05/09/2023 FLOOD ELEV. N/A

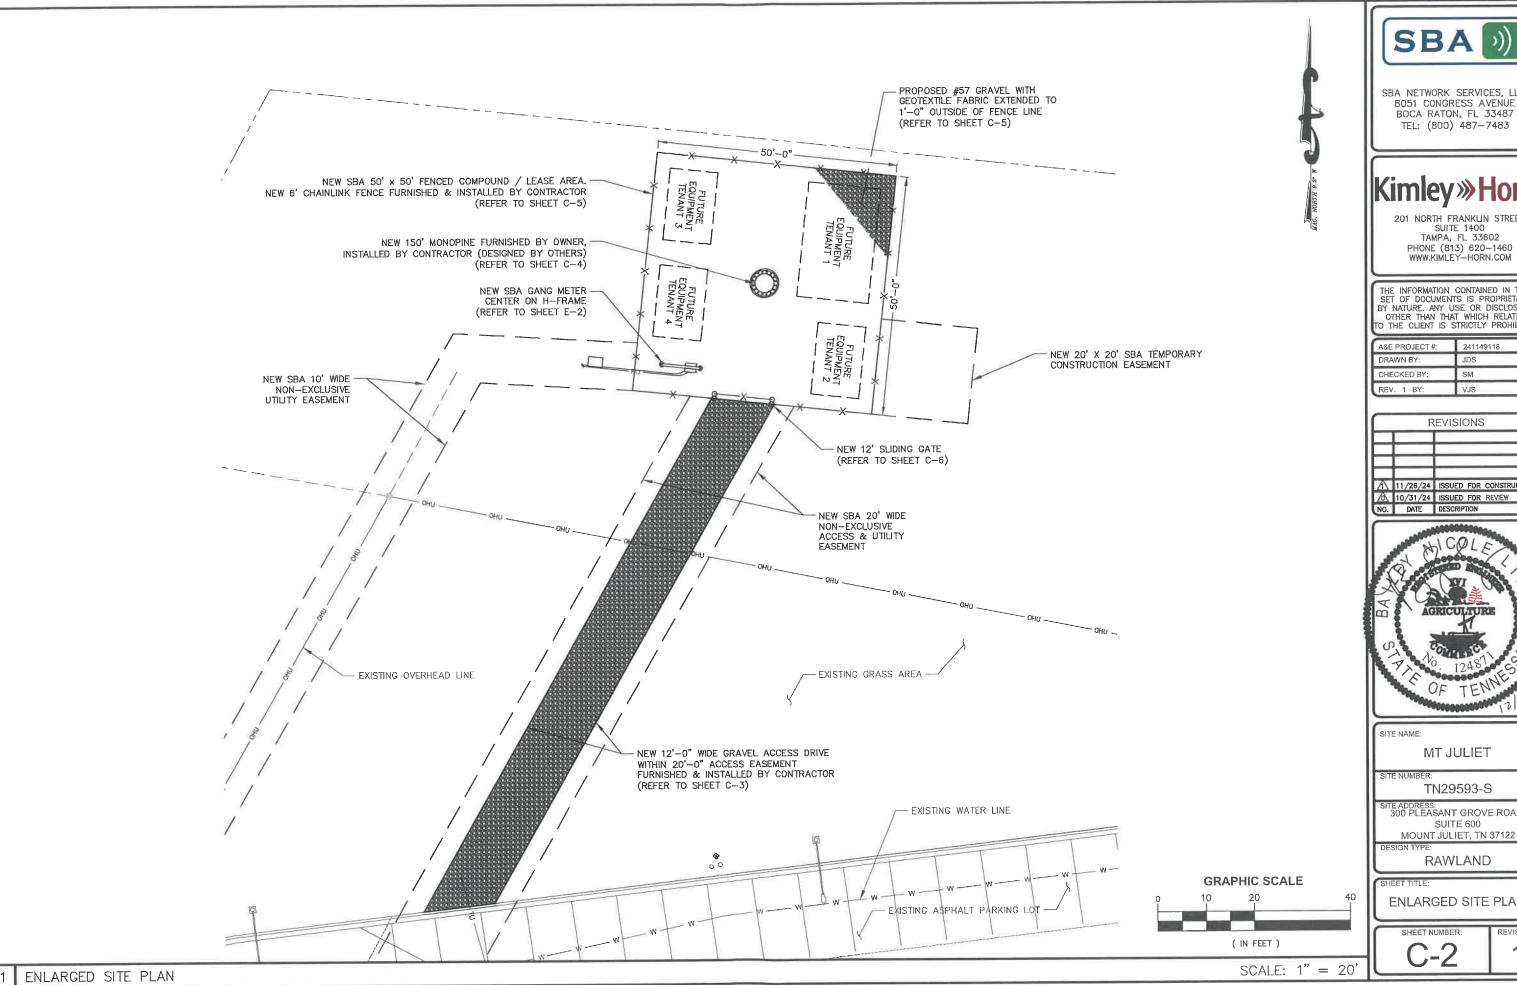



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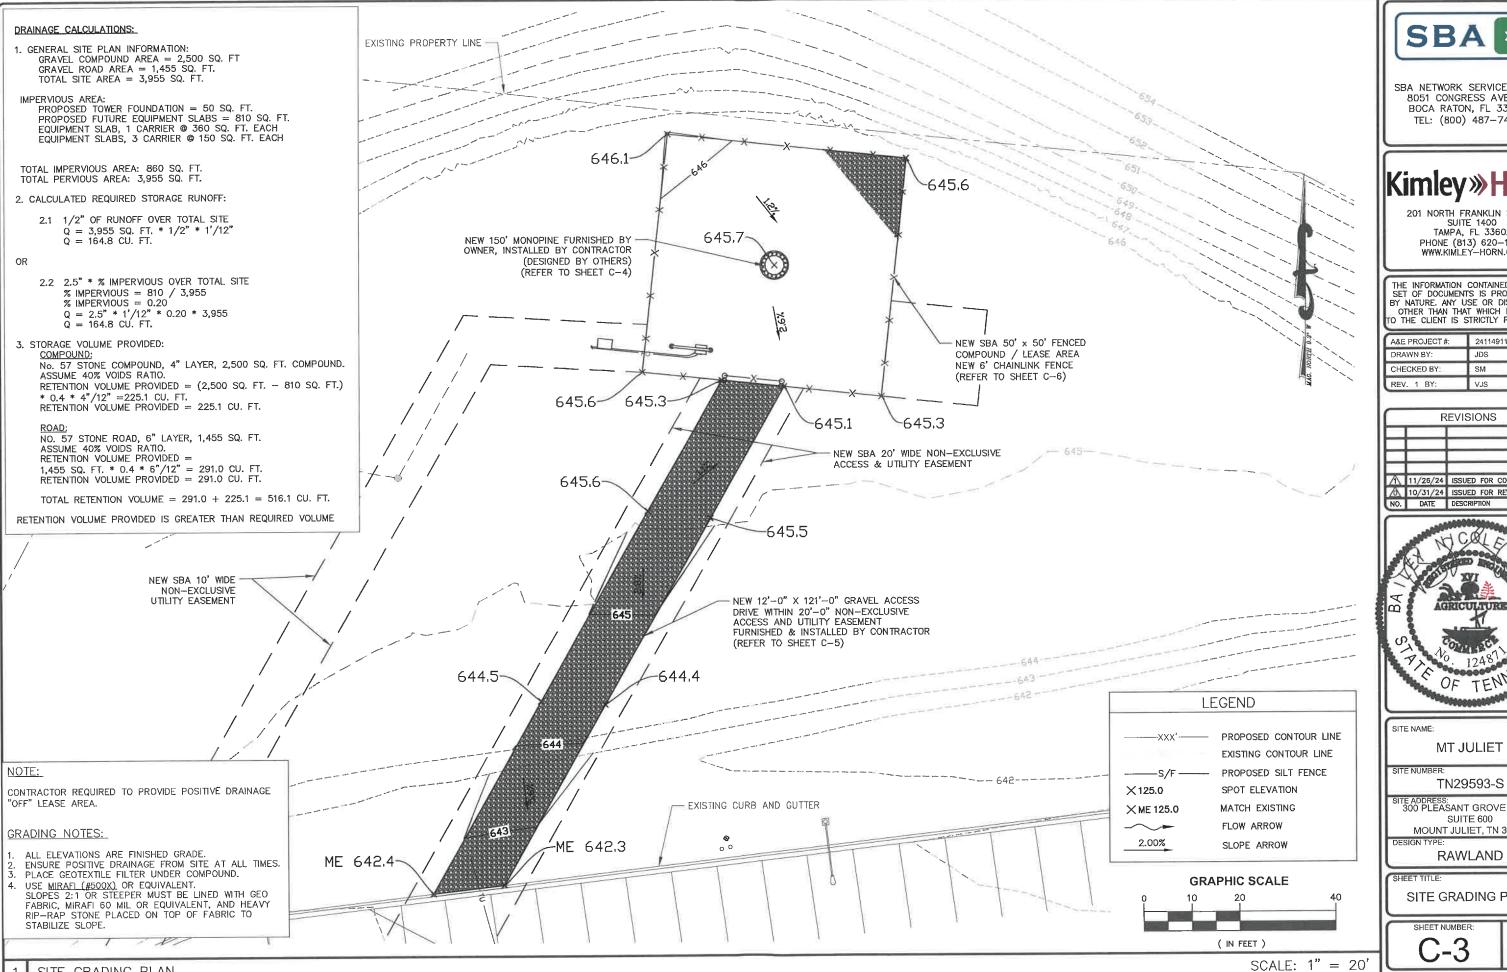
- 1	A&E PROJECT #:	241149118
- 1	DRAWN BY:	JDS
- 1	CHECKED BY:	SM
- 1	REV. 1 BY:	VJS

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16	10/31/24	ISSUED FOR REVIEW	
NO.	DATE	DESCRIPTION	



ITE ADDRESS: 300 PLEASANT GROVE ROAD, SUITE 600

ENLARGED SITE PLAN



SBA

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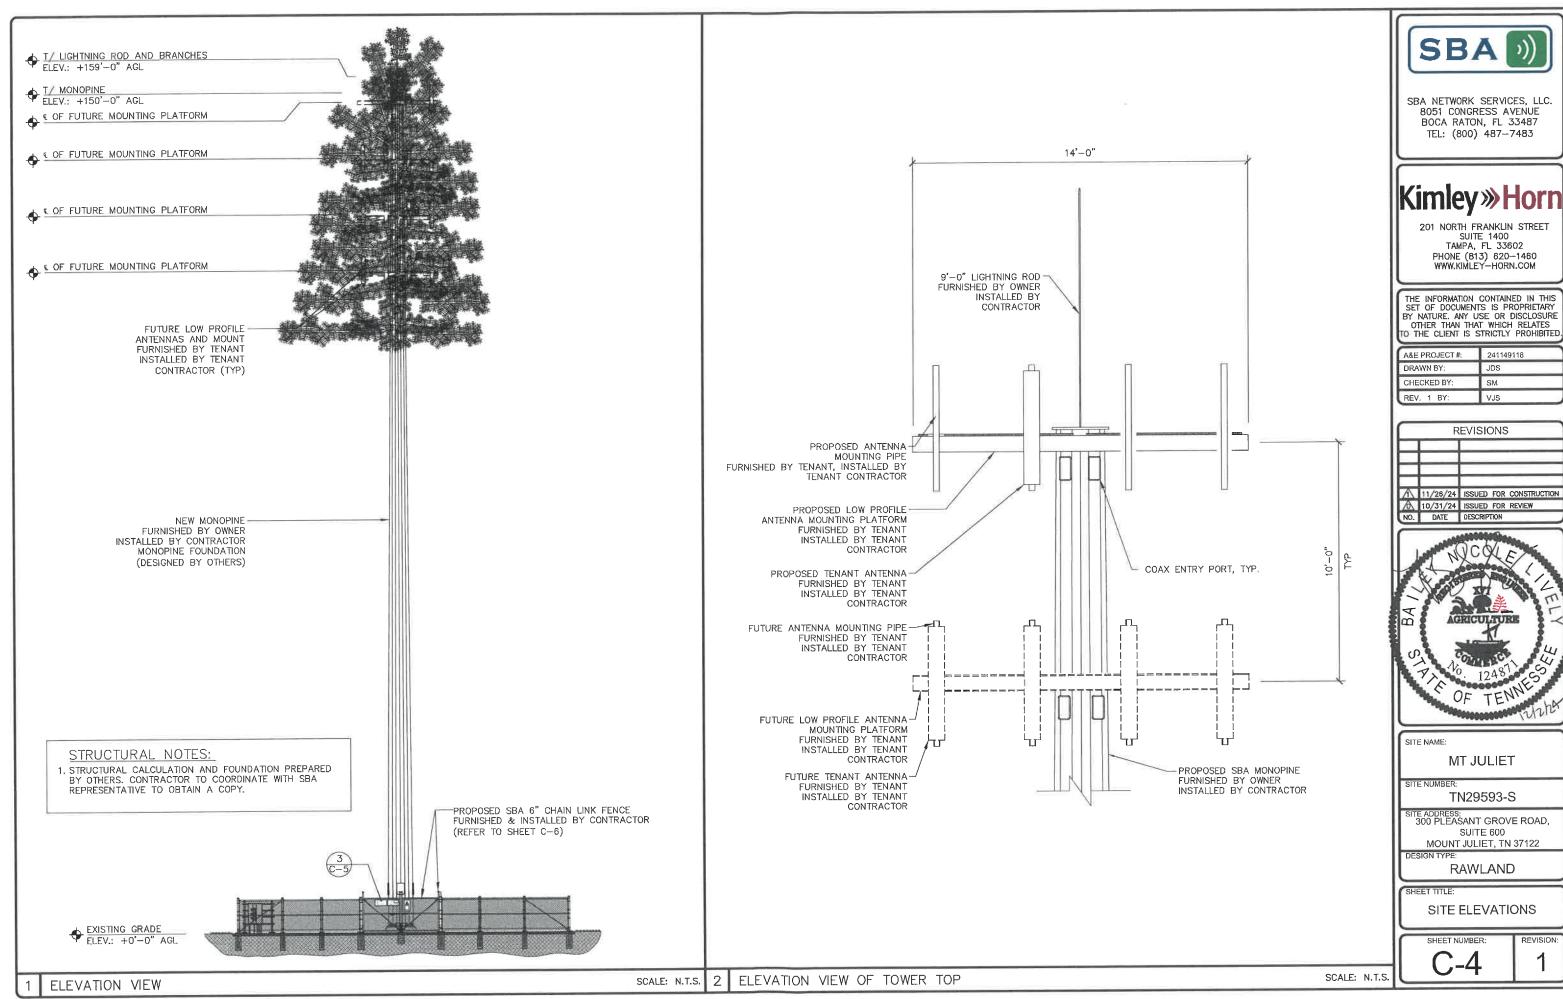
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À	11/26/24	ISSUED FOR CONSTRUCTION	
A	10/31/24	ISSUED FOR REVIEW	
NO.	DATE	DESCRIPTION	



MT JULIET

ite address: 300 PLEASANT GROVE ROAD, SUITE 600 MOUNT JULIET, TN 37122


SITE GRADING PLAN



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Λ	11/26/24	ISSUED FOR CONSTRUCTION
B	10/31/24	ISSUED FOR REVIEW
NO.	DATE	DESCRIPTION



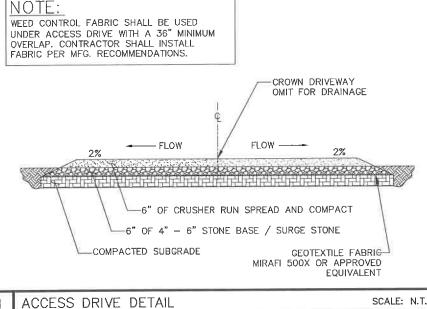

NOTE:

WEED CONTROL FABRIC SHALL BE USED UNDER ENTIRE PROPOSED GRAVELED AREA WITH A 36" MINIMUM OVERLAP, CONTRACTOR SHALL INSTALL FABRIC PER MFG. RECOMMENDATIONS.

NEW 4" THICK (MIN.) #57 WASHED STONE—SLOPE TO MAINTAIN POSITIVE DRAINAGE, COMPACT TO 90% OF THE STANDARD PROCTOR MAXIMUM DRY DENSITY (ASTM D-698)

NEW WEED CONTROL FABRIC, TENCATE MIRAFI WOVEN POLYPROPYLENE HP-370 GEOTEXTILE OR APPROVED EQUIVALENT

SUITABLE UNDISTURBED SUBGRADE. -REMOVE ALL ORGANIC OR UNSUITABLE MATERIAL AND COMPACT TO 90% OF THE STANDARD PROCTOR MAXIMUM DRY DENSITY (ASTM D-698)

NEW 3" THICK (MIN.) ABC (CRUSHER RUN) STONE-SLOPE T MAINTAIN POSITIVE DRAINAGE, COMPACT TO 90% OF THE

NO SBA D ENTRY ONLY NETWORK SERVICES, INC. 1 - 8 0 0 - 8 2 5 - 7 0 2 9 WARNING CAUTION NOTICE
HAND PATS
REQUIRED IN THIS AUTHORISE PERCENTEL
ONL (DO NOT CLIMB ANTENNAS MAY BE TOWNERS WRITTEN
ACTIVE AUTHORIZATION 18"x24" .040 NEAREST HOSPITAL: ALUMINUM EMERGENCY #:

24"x18" SF C-X PLASTIC (TEMP) FCC #: XXXXXXX SBA D 4"x18" .040 ALUMINUM.

NOTE:

CONTRACTOR TO POST THE

SITE CONSTRUCTION.

TEMPORARY SIGNS PRIOR TO

SBA TOWERS SITE I.D.#: EMERGENCY (888) 950-SITE (7483) LEASING (809)487-SITE (7483) 18"x24" SF C-X PLASTIC (TEMP)

SBA SITE I.D.#: FCC#: LEASING (800)487-SITE (7483) EMERGENCY (888) 950-SITE (7483) WWW.SBASITE.COM 12"x24"x.063 ALUMINUM

CAUTION 18"x12" .040

ALUMINUM

CLOSED

18"x12" .040 ALUMINUM

SCALE: N.T.S

PLEASE

KEEP

GATE

201 NORTH FRANKLIN STREET SUITE 1400 TAMPA, FL 33602 PHONE (813) 620-1460 WWW,KIMLEY-HORN.COM

SBA

SBA NETWORK SERVICES, LLC.

8051 CONGRESS AVENUE

BOCA RATON, FL 33487

TEL: (800) 487-7483

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- 1	REV. 1 BY:	VJS

REVISIONS 11/26/24 ISSUED FOR CONSTRUCTION 10/31/24 ISSUED FOR REVIEW NO. DATE DESCRIPTION



SITE NAME

MT JULIET

SITE NUMBER TN29593-S

ITE ADDRESS: 300 PLEASANT GROVE ROAD, SUITE 600

MOUNT JULIET, TN 37122

RAWLAND

SITE DETAILS

SHEET NUMBER

SCALE: N.T.S.

2 COMPOUND FINISH DETAIL SCALE: N.T.S.

STANDARD PROCTOR MAXIMUM

DRY DENSITY (ASTM D-698)


SIGN DETAIL

NOTES:

- CONTRACTOR SHALL BE RESPONSIBLE FOR CONSTRUCTION AND MAINTENANCE OF EROSION AND SEDIMENTATION CONTROLS DURING CONSTRUCTION. INSTALL SILT FENCE AS SHOWN WHERE ADDITIONALLY REQUIRED FOR PROTECTION OF ADJACENT PROPERTIES, ROADWAYS, AND WATERWAYS.
- CONTRACTOR SHALL INSPECT INSTALLED EROSION CONTROL DEVICE WEEKLY DURING CONSTRUCTION AND AFTER HEAVY RAINS FOR DAMAGE OR EXCESSIVE SILTATION, MAINTENANCE SHALL INCLUDE CLEANING BUILT-UP SEDIMENT BEHIND THE BARRIERS AND/OR REPLACING DAMAGED SECTIONS.
- THE EROSION CONTROL DEVICES SHALL BE MAINTAINED BY THE CONTRACTOR UNTIL PERMANENT STABILIZATION IS
- 4. HAY BALES SHALL NOT BE USED AS EROSION CONTROL.
- CONTRACTOR IS RESPONSIBLE FOR PROVIDING SITE FREE OF DRAINAGE PROBLEMS.
- CONTRACTOR SHALL USE BEST MANAGEMENT PRACTICES FOR CONSTRUCTION TO PREVENT THE DIVERSION OF SEDIMENT LADEN STORM WATER RUNOFF OR ERODED MATERIALS FROM LEAVING THE CONSTRUCTION SITE
- CONTRACTOR SHALL PREVENT TRACKING OF SEDIMENT OUTSIDE OF CONSTRUCTION LIMITS. THIS MAY REQUIRE CLEANING AND/OR WASHING OF DEBRIS AND SEDIMENT FROM ALL VEHICLES PRIOR TO EXITING THE SITE. ANY SEDIMENT DEPOSITED ON THE ROADWAY SHALL BE SWEPT AS NECESSARY THROUGHOUT THE DAY OR AT THE END OF EVERY DAY AND DISPOSED OF IN AN APPROPRIATE MANNER. SEDIMENT SHALL NOT BE WASHED INTO STORM SEWER SYSTEMS.
- ANY DEBRIS AND/OR SEDIMENT EXITING THE SITE DUE TO TRACKING OR FAILURE OF A SITE BMP SHALL BE CLEANED IMMEDIATELY BY THE CONTRACTOR BY A METHOD OTHER THAN FLUSHING. CONTRACTOR SHALL ALSO IMMEDIATELY REPAIR ANY BMPS THAT HAVE FAILED AND/OR INSTALL ADDITIONAL BMPS TO ENSURE SEDIMENT DOES NOT LEAVE



SET POSTS AND EXCAVATE A 4"X4" TRENCH UPSLOPE ALONG

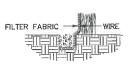

3. ATTACH THE FILTER FABRIC TO THE WIRE FENCE AND EXTEND IT INTO THE TRENCH.


2. STAPLE WIRE FENCING TO THE LINE OF POSTS.

SILT FENCE

EROSION CONTROL DETAIL

SCALE: N.T.S.

REVISION

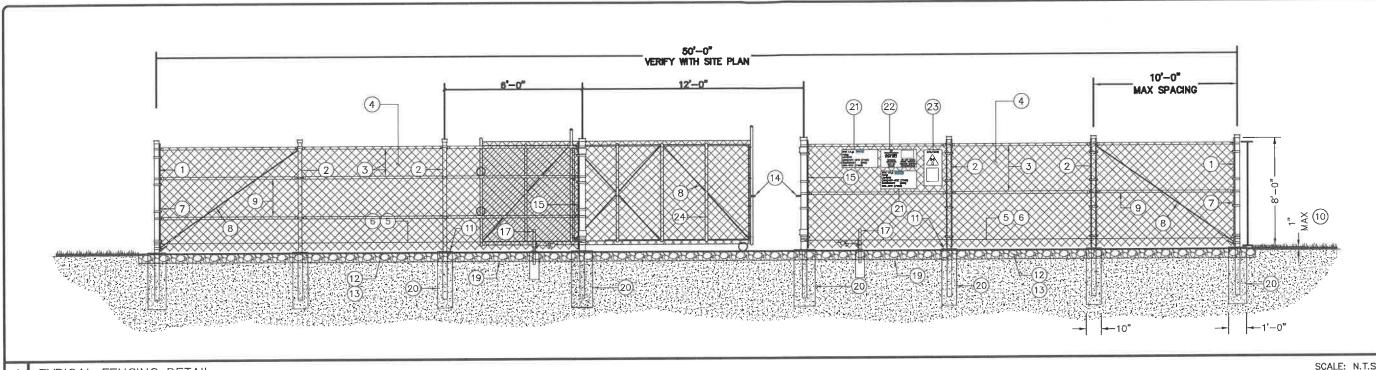

TYPICAL FENCING DETAIL

GENERAL NOTES:

- 1. INSTALL FENCING PER ASTM F-567
- 2. INSTALL SWING GATES PER ASTM F- 900
- 3. LOCAL ORDINANCE OF BARBED WIRE PERMIT REQUIREMENT SHALL BE COMPLIED IF REQUIRED.
- 4. POST & GATE PIPE SIZES ARE INDUSTRY STANDARDS. ALL PIPE TO BE GALVANIZED (HOT DIP, ASTM A120 GRADE "A" STEEL). ALL GATE FRAMES SHALL BE WELDED. ALL WELDING SHALL BE COATED WITH (3) COATS OF COLD GALV. (OR EQUIVALENT).
- 5. ALL OPEN POSTS SHALL HAVE END-CAPS.
- 6. USE GALVANIZED HOG-RING WIRE TO MOUNT ALL SIGNS.
- 7. ALL SIGNS MUST BE MOUNTED ON INSIDE OF FENCE FABRIC.
- 8. MUSHROOM ANCHOR & PLUNGER REQUIRED FOR GATE.
- 9. G.C. RESPONSIBLE FOR SBA COMBO GATE LOCK

BALLOON REFERENCE NOTES:

- (1) CORNER, END OR PULL POST: 3" O.D. SCHEDULE 40 PIPE.
- 2) LINE POST: 2 1/2" NOMINAL SCHEDULE 40 PIPE, PER ASTM-F1083. LINE POSTS SHALL BE EQUIVALENTLY SPACED AT MAXIMUM 10'-0" O.C.
- TOP RAIL & BRACE RAIL: 1-5/8"O.D. STANDARD ROUND PIPE, PER
- 4) FABRIC: 9 GA CORE WIRE SIZE 2" MESH, CONFORMING TO ASTM-A392
- TIE WIRE: 9 GA ALUMINUM. A SINGLE WRAP OF FABRIC TIE AND AT TENSION WIRE BY HOG RINGS SPACED 12" O.C. POSTS/GATES AND 24" RAILS/WIRE.
- (6) TENSION WIRE: 9 GA ALUMINUM
- (7) 3/16" x 3/4" (MIN) FULL HEIGHT STRETCHER BAR
- 3/8" DIAGONAL ROD WITH GALVANIZED STEEL TURNBUCKLE OR DIAGONAL THREADED ROD.
- (9) FENCE CORNER POST BRACE: 1 5/8" NOMINAL PIPE.
- (10) 1" MAXIMUM CLEARANCE FROM FINISH GRADE.
- (11) FENCE POST FOUNDATION TO BE 1" FINISH ABOVE FINISHED GRADE
- (12) 6" COMPACTED BASE MATERIAL
- (13) FINISH GRADE SHALL BE UNIFORM AND LEVEL.
- (14) LATCH & CATCH AS REQUIRED
- (15) GATE POST 4" O.D., SCHEDULE 40 PIPE, PER ASTM-F1083.
- (16) GATE FRAME BRACE RAIL: 1 1/2" NOMINAL PIPE, PER ASTM-F1083.
- 17) DUCK BILL OPEN GATE HOLDER. VERIFY LOCATION IN FIELD PRIOR TO INSTALLATION.
- (18) STYMIE LOCK MULTI-TENANT LOCKING DEVICE
- (19) GEOTEXTILE FABRIC
- 20 CONCRETE FOUNDATION (MIN 4000 PSI). MINIMUM DEPTH: 6" BELOW FROST LINE
- (21) 12" x 24" SBA SITE INFORMATION SIGN.
- (22) 12" x 24" NO TRESPASSING SIGN.
- (23) 12" x 24" RF CAUTION SIGN.
- (24) 2" SCH. 40 PIPE AT EACH END & 1/3 POINTS IN OVERALL FRAME

SBA

SBA NETWORK SERVICES, LLC. 8051 CONGRESS AVENUE BOCA RATON, FL 33487 TEL: (800) 487-7483

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-1	A&E PROJECT#:	241149118	
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	CHECKED BY:	SM	
٦	REV. 1 BY:	VJS	0

	R	EVISIONS
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Λ	11/26/24	ISSUED FOR CONSTRUCTION
1	10/31/24	ISSUED FOR REVIEW
NO.	DATE	DESCRIPTION



MT JULIET

TN29593-S

TE ADDRESS: 300 PLEASANT GROVE ROAD, SUITE 600

MOUNT JULIET, TN 37122

RAWLAND

FENCE DETAILS

4 NOT USED

GENERAL NOTES

SCALE: N.T.S.

FENCING NOTES

SCALE: N.T.S.

SCALE: N.T.S

LINES SHOWN DO NOT REPRESENT THE EXACT LOCATION OF THE CONDUIT RUNS. CONTRACTOR TO VERIFY SERVICE LOCATIONS w/ACTUAL FIELD CONDITIONS. REFER TO UTILITY COORDINATION DOCUMENT FOR CONDUIT RUNS AND ASSOCIATED PARAMETERS (BY OTHERS). NEW SBA 50' x 50' FENCED COMPOUND / LEASE AREA NEW 150' MONOPINE NEW POWER HANDHOLE -(BY OTHERS) NEW U/G POWER FROM NEW POWER HANDHOLE TO NEW METER CENTER. (2) 4" SCH 40 PVC. EXTEND OUTSIDE COMPOUND 5' MINIMUM. COORDINATE W/ UTILITY COMPANY FOR ROUTING. NEW SBA UTILITY CENTER PROVIDED BY AND INSTALLED BY CONTRACTOR NEW SBA 10' WIDE (REFER TO SHEET E-2) NON-EXCLUSIVE UTILITY EASEMENT PROPOSED U/G FIBER ROUTED TO RIGHT-OF-WAY (BY OTHERS) **GRAPHIC SCALE**

GENERAL ELECTRICAL NOTES

- 1.) ALL ELECTRICAL WORK SHALL CONFORM TO NATIONAL ELECTRIC CODE, LATEST ADOPTED EDITION, AND LOCAL CODES.
- 2.) ALL ELECTRICAL MATERIALS, EQUIPMENT AND INSTALLATION PROCEDURES TO CONFORM WITH SBA SPECIFICATIONS.
- 3.) CONTRACTOR SHALL PERFORM ALL VERIFICATION TESTS AND EXAMINATION WORK PRIOR TO THE ORDERING OF THE ELECTRICAL EQUIPMENT AND THE ACTUAL CONSTRUCTION. CONTRACTOR SHALL ISSUE A WRITTEN NOTICE OF ALL FINDINGS TO THE ENGINEER LISTING ALL MALFUNCTIONS, FAULTY EQUIPMENT & DISCREPANCIES.
- 4.) ELECTRICAL PLANS, DETAILS, AND DIAGRAMS ARE DIAGRAMMATIC ONLY. FIELD CONDITIONS DICTATE THE AMOUNT AND LOCATION OF EQUIPMENT.
- 5.) ALL MATERIALS SHALL BE MANUFACTURED IN ACCORDANCE WITH APPLICABLE STANDARDS ESTABLISHED BY ANSI, NEMA, NFPA, AND "UL" LISTED.
- 6.) THE ENTIRE ELECTRICAL INSTALLATION SHALL BE GROUNDED AS REQUIRED BY THE NEC, AND ALL APPLICABLE LOCAL CODES.
- 7.) ALL CIRCUIT BREAKERS, FUSES AND ELECTRICAL EQUIPMENT SHALL HAVE A MINIMUM INTERRUPTING RATING GREATER THAN THE UTILITY FAULT CURRENT.
- 8.) FOR COMPLETE INTERNAL WIRING AND ARRANGEMENT REFER TO VENDOR PRINTS AND INSTRUCTIONS.
- 9.) PATCH, REPAIR AND PAINT ANY AREA THAT HAS BEEN DAMAGED IN THE COURSE OF THE ELECTRICAL WORK.
- 10.) PROVIDE SBA WITH ONE SET OF COMPLETE ELECTRICAL "AS-BUILT" DRAWINGS AT THE COMPLETION OF THE JOB SHOWING ACTUAL ROUTINGS AND WIRING CONNECTIONS.
- 11.) LABEL ALL ELECTRICAL EQUIPMENT PER SBA SPECIFICATIONS.
- 12.) ALL SINGLE-PHASE SELF-CONTAINED METER CONNECTION DEVICES MUST INCLUDE HORN TYPE BY-PASS PROVISION SO THAT SERVICE WILL NOT BE INTERRUPTED WHEN A METER IS REMOVED FROM THE SOCKET.
- 13.) ALL EQUIPMENT PUNCH OUTS AND CONDUITS (USED AND SPARE) TO BE "RODENT PROOFED" WITH CAPS, STEEL MESH, AND/OR FOAM FILL BY CONTRACTOR (AS NEEDED).
- 14.) ALL INTERIOR CONDUITS AND BUSHINGS SHALL BE EMT. ALL EXTERIOR SHALL BE PVC UNLESS NOTED OTHERWISE. SEE SBA SPECIFICATIONS.
- 15.) NO SPOILS TO BE LEFT ON SITE WITHOUT THE WRITTEN CONSENT OF THE LANDOWNER
- 16.) CONTRACTOR TO PROVIDE 2 PHENOLIC LABELS AT METER. ONE TO IDENTIFY "SBA DISCONNECT" AND THE OTHER TO GIVE SITE ADDRESS.

CODES AND STANDARDS

ANSI AMERICAN NATIONAL STANDARDS INSTITUTE
NEC NATIONAL ELECTRICAL CODE, LATEST ADOPTED EDITION
NEMA NATIONAL ELECTRICAL MANUFACTURER'S ASSOCIATION
NFPANATIONAL FIRE PROTECTION ASSOCIATION
UL UNDERWRITERS LABORATORIES, INC.



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Kimley » Horn

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241149118
JDS
SM
VJS

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	Date -
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1 11/26/24	ISSUED FOR CONSTRUCTION
0 10/31/24	ISSUED FOR REVIEW
NO. DATE	DESCRIPTION



SITE NAME

MT JULIET

TN29593-S

TE ADDRESS: 300 PLEASANT GROVE ROAD, SUITE 600

MOUNT JULIET, TN 37122

RAWLAND

SHEET TITLE

UTILITY SITE PLAN


SHEET NUMBER:

REVISION

UTILITY SITE PLAN

SCALE" 1" = 10'

(IN FEET)

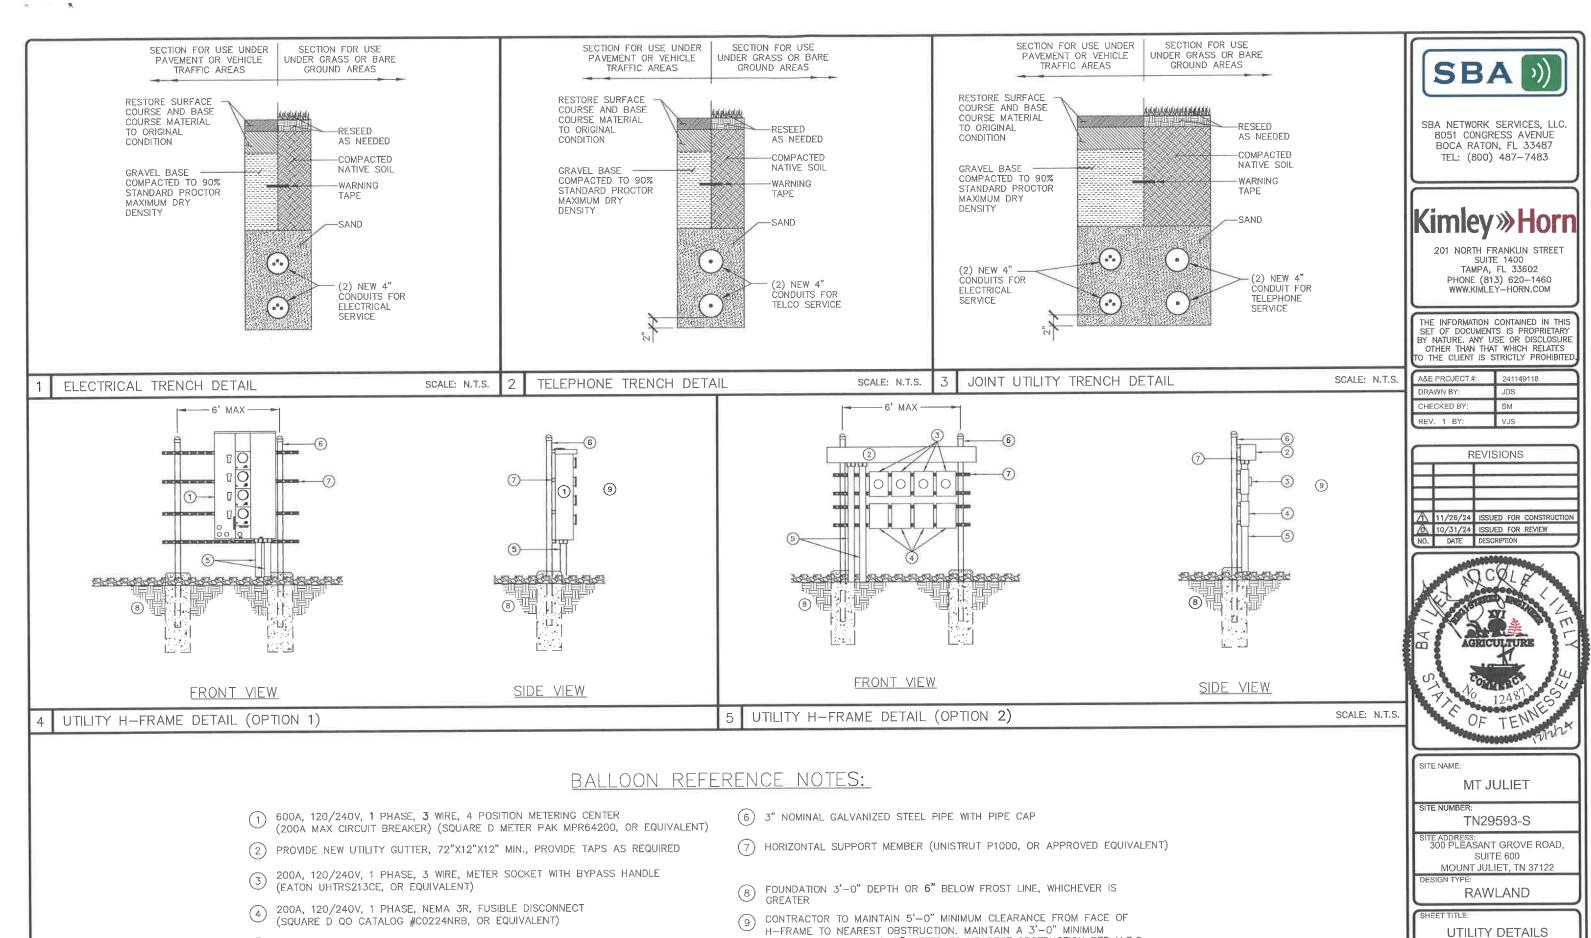

CLEARANCE FROM FACE OF METER TO NEAREST OBSTRUCTION PER N.E.C.

SCALE: N.T.S

E 2

L-2

| 1

UTILITY & TELCO H-FRAME DETAIL

(2) SCH. 40 PIPE FOR ELECTRIC SERVICE (SEE ONE LINE DIAGRAM)

		ELI	ECTRICAL	
CIRCUIT ID	VOLTS	MAX ONE WAY LENGTH OF RUN	CIRCUIT SIZE (2H+N)	CONDUIT Ø
	120/240V	300FT	2 PARALLEL SETS (3) 350 MCM	(2) 3-1/2"
		350FT	2 PARALLEL SETS (3) 400 MCM	(2) 3-1/2"
F 4 7		450FT	2 PARALLEL SETS (3) 500 MCM	(2) 4"
[A]		500FT	2 PARALLEL SETS (3) 600 MCM	(2) 4"
		600FT	2 PARALLEL SETS (3) 700 MCM	(2) 4"
		650FT	2 PARALLEL SETS (3) 750 MCM	(2) 4"

CIRCUITS SIZED FOR LESS THAN 3.0% OF VOLTAGE DROP
 PARALLEL SETS OF WIRES, EACH SET IN SEPARATE CONDUIT
 ALL CIRCUITS SHALL BE CU, AWG, THWN

SBA D)

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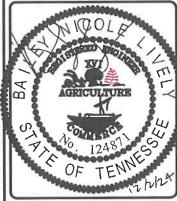
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SUITE 600 MOUNT JULIET, TN 37122

N TYPE:


RAWLAND

ELECTRICAL DETAILS

SHEET NUMBER

1

METERING CENTER, 600A, 120/240V, 1 PHASE 200A 200A M 200A M 200A M EXISTING GRADE	PROVIDE NEW UTILITY GUTTER, 72"X12"X12" MIN., PROVIDE TAPS AS REQUIRED 200A, 120/240V, 1 PHASE, MITH BYPASS HANDLE 200A, 120/240V, 1 PHASE, NEMA 3R, FUSIBLE DISCONNECT 200A, 000 200A 000 20	EXISTING GRADE
1 ELECTRICAL SINGLE—LINE DIAGRAM (OPTION 1) SCALE: N.T.S.	2 ELECTRICAL SINGLE-LINE DIAGRAM (OPTION 2)	SCALE: N.T.S.
1 ELECTRICAL SINGLE—LINE DIAGRAM (OPTION 1) SCALE: N.T.S.	Z ELLOTRICAL SHOLL LINE BINGRAM (OF HOR Z)	33

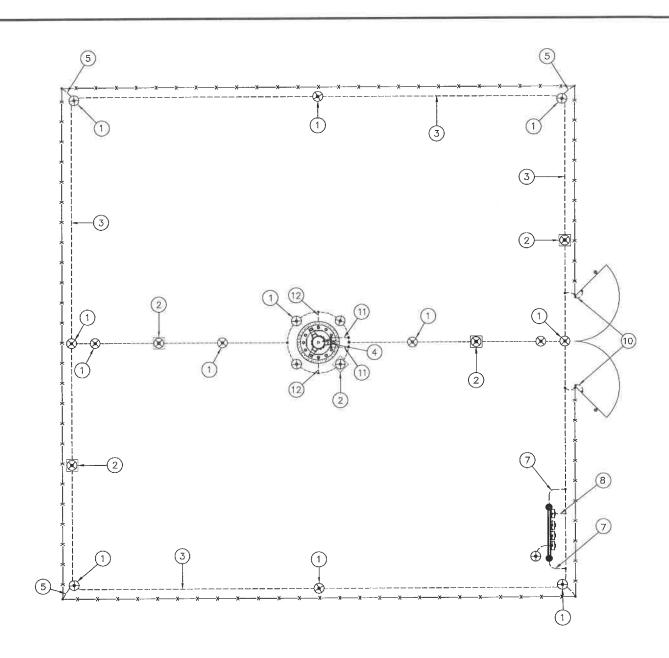


BALLOON REFERENCE NOTES:

- 2) GROUND ROD ACCESS WELL (MIN. OF 4 EACH PER COMPOUND)
- #2 SOLID, TINNED, BARE COPPER WIRE GROUND RING (CONTINUOUS STRAND)
- 1/4"X4"X20" TINNED COPPER GROUND BAR. 2 TYP, AT BASE AND TOP OF TOWER. MOUNT DIRECT TO TOWER, DO NOT ISOLATE.
- (5) #2 SOLID, TINNED, BARE COPPER WIRE GROUND LEAD TO FENCE CORNER POST.
- 7) #2 SOLID, TINNED, BARE COPPER WIRE GROUND LEAD TO UTILITY H-FRAME SUPPORT POST
- (8) SERVICE ENTRANCE GROUND TO DEDICATED GROUND ROD
- 9 N/A

GROUND ROD WITH ACCESS MECHANICAL CONNECTION GROUND ROD GROUND BAR


SYMBOLS LEGEND

EXOTHERMIC CONNECTION GROUND WIRE

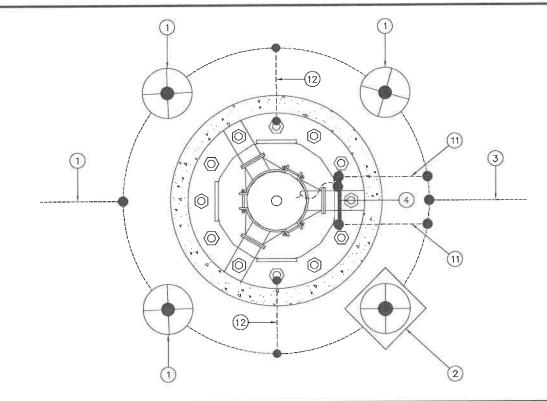

ENLARGED GROUNDING PLAN @ TOWER BASE (TYP)

N.T.S.

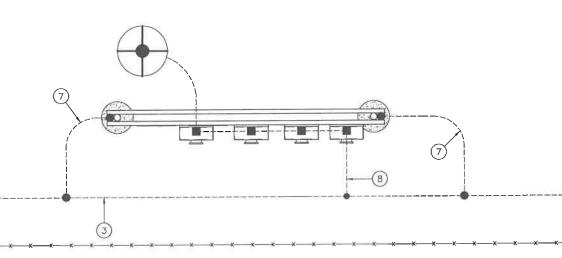



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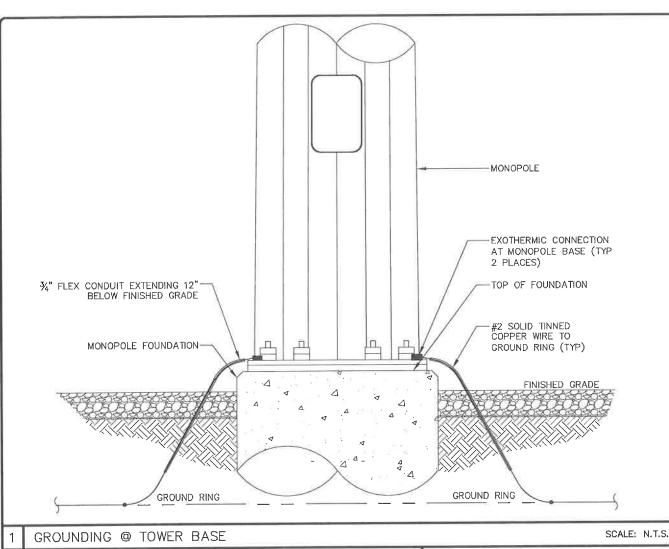
MOUNT JULIET, TN 37122

RAWLAND

GROUNDING PLAN & DETAILS

EG-

- (1) 5/8"~X8' COPPER CLAD GROUND ROD BURIED 36" BELOW GRADE (MIN.) #2 INSULATED, STRANDED COPPER BOND STRAP FROM GATE FRAME TO GATE POST. (TYP EACH GATE)
 - #2 SOLID, TINNED, BARE COPPER GROUND LEAD FROM GROUND BAR AT MONOPOLE BASE TO GROUND RING. ROUTE IN 3/4" FLEX CONDUIT AND WEATHERPROOF OPEN END. (2 TYPICAL)
 - #2 SOLID, TINNED, BARE COPPER GROUND LEAD FROM MONOPOLE BASE TO GROUND RING. (2 TYPICAL, 180" SEPARATION)



CADWELD CONNECTIONS (OR APPROVED EQUIVALENT)



PARALLEL HORIZONTAL CONDUCTORS PARALLEL THROUGH CONNECTION OF HORIZONTAL CABLES TYPE PT



THROUGH CABLE TO GROUND ROD THROUGH CABLE TO TOP OF GROUND ROD TYPE



HORIZONTAL SPLICE SPLICE OF HORIZONTAL CABLES



HORIZONTAL STEEL SURFACE TO FLAT STEEL SURFACE OR HORIZONTAL PIPE TYPE



VERTICAL STEEL SURFACE CABLE DOWN AT 45° TO VERTICAL STEEL SURFACE INCLUDING PIPE TYPE VS



VERTICAL PIPE CABLE DOWN AT 45° TO RANGE OF VERTICAL PIPES TYPE VS

BURNDY CONNECTIONS (OR APPROVED EQUIVALENT)



"C" CONNECTOR HYPRESS TYPE YGHC



BOND JUMPER FIELD FABRICATED GREEN STRANDED INSULATED TYPE 2-YA-2



COPPER LUGS TWO HOLE - LONG BARREL LENGTH TYPE YA-2

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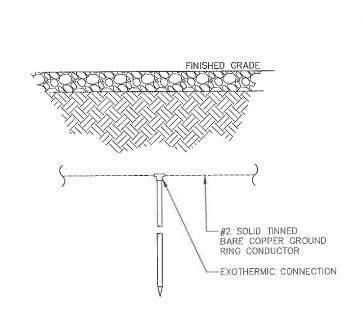
GROUNDING DETAILS


EG-2


TYPICAL WELDING CONNECTIONS SCALE: N.T.S.

PENTEK OR EQUIVALENT 6"ø ECONO TURF BOX WITH LOCKING DROP-IN LID. INSERT 6"¢ X 36" SCH 40 PVC TEST WELL PIPE INTO TURF BOX AND SECURE WITH PVC GLUE. USE PENTEK PART #182101. FINISHED GRADE #2 BTW TEST WIRE WHERE APPLICABLE EXOTHERMIC CONNECTION #2 SOLID TINNED BARE COPPER GROUND RING CONDUCTOR 8" MIN. CRUSHED STONE

ACCESS WELL DETAIL



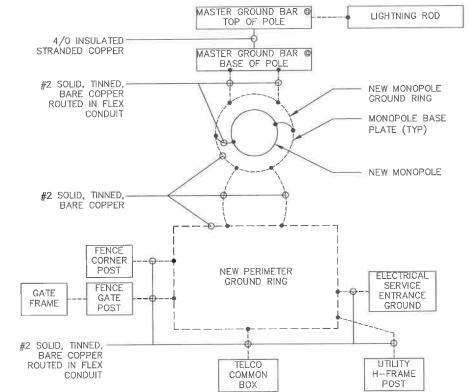

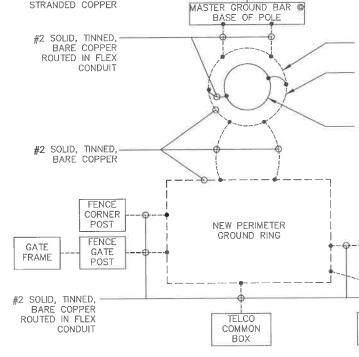

SCALE: N.T.S.

SCALE: N.T.S.

SINGLE-LINE DIAGRAM

GROUNDING ROD DETAIL

SCALE: N.T.S